

Dwg. No.



OCCUPANCY GROUP: B (BUSINESS) TYPE OF CONSTRUCTION: V-B UN-SPRINKLERED.

MAXIMUM ALLOWED STORIES (TABLE 503): 2 PROPOSED STORIES: 2

MAXIMUM ALLOWED AREA PER FLOOR AND HEIGHT (TABLE 503): 9,000 SF, 40' H. PROPOSED SQUARE FEET:

FLOOR 1: 3,238 SF FLOOR 2: 2,757 SF TOTAL AREA: 5,995 SF HEIGHT: 32'

NUMBER OF EXITS PROVIDED: FIRST FLOOR: 1 SECOND FLOOR: 1 MAXIMUM OCCUPANTS AND TRAVEL DISTANCE BASED ON NUMBER OF EXITS (TABLE 1021.2):

FIRST FLOOR: 49 OCCUPANTS, 75 FEET. SECOND FLOOR: 29 OCCUPANTS, 75 FEET. TOTAL OCCUPANTS: 78

WEST & SOUTH SEPARATION: 1 HOUR RATING.

FIRE-RESISTANCE RATING REQUIREMENTS FOR BUILDING ELEMENTS (TABLE 503): ALL ELEMENTS: 0 RATING.


FIRE-RESISTANCE RATING REQUIREMENTS FOR EXTERIOR WALLS BASED ON FIRE **SEPARATION DISTANCE (TABLE 602):** EAST & NORTH SEPARATION: 0 RATING

MAXIMUM UNPROTECTED OPENINGS IN RATED WALLS (TABLE 705.8): 10% **ACTUAL UNPROTECTED OPENINGS IN RATED WALLS: 10%** 

SEPARATION OF OCCUPANCIES TABLE 508.4 (B TO B): NO SEPARATION REQUIREMENT.

SHAFT ENCLOSURE - ELEVATOR HOISTWAY AND MACHINE ROOM (SECTION 708.4): 1 HR RATED.

EXIT ENCLOSURE - STAIRS (SECTION 1022.1): 1 HR RATED. EXIT PASSAGEWAY - FIRST FLOOR LOBBY (SECTION 1023.3): 1 HR RATED.

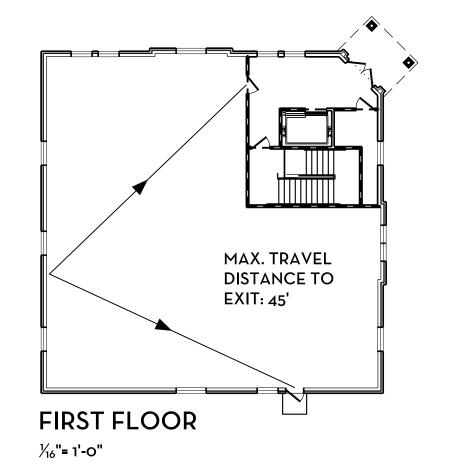

MAX. TRAVEL DISTANCE TO

MAX. SECOND

OCCUPANCY:

SECOND FLOOR

½"= 1'-0"

EXIT: 65'

**FLOOR** 

—INDICATES 1 HOUR RATED WALL

NO.

NTS

OVFL

OVHD

OPNG

PREFIN

PREFAB

PLAM

PLAS

R/A

RCP

RECES

RECPT

REFL

REF

REQD

REINF

RESIL

REST

RFG

ROW

SGL SGHC

STD

STL

STRFR

STRUCT

SURF

SUSP

SYS

PLYWD

OPR

**NOT IN CONTRACT** 

NOT TO SCALE

**OVERFLOW** 

**OVERHEAD** 

OPENING(S)

**OPERABLE** 

**PARTITION** 

PREFINISHED

**PREFABRICATED** 

PLASTIC LAMINATE

HVAC RETURN AIR

**REFLECTED CEILING PLAN** 

PANEL

**PLASTER** 

PLYWOOD

**RECESSED** 

REFER

RECEPTACLE

REFLECTED

REQUIRED

RESILIENT

**RESTROOM** 

ROOFING

ROOM

SINGLE

SIMILAR

STEEL

STANDARD

**STOREFRONT** 

STRUCTURAL

SUSPENDED

SYSTEM(S)

SURFACE

REFRIGERATOR

REINFORCE(D)

**ROUGH OPENING** 

SQUARE FOOT (FEET)

**SOLAR HEAT GAIN** 

STAINLESS STEEL

COEFFICIENT

RIGHT OF WAY

**OPPOSITE HAND** 

PARTICLE BOARD

NUMBER

TBD

THK

TLT

TRANS

TRTD

T&G

TYP

UTIL

UNO

UWA

VIF

TILE CPT

TO BE DETRMINED

**TONGUE & GROOVE** 

**UNDER WALL ABOVE** 

**VERIFY IN FIELD** 

WATER CLOSET

**WASHER & DRYER** 

WATERPROOF(ING)

**GRAPHIC SYMBOLS:** 

DOOR NUMBER

FINISH DOOR WIDTH

WINDOW REFERENCE NUMBER

FLOOR FINISH MATERIALS

**ALIGN SURFACES WHICH** 

-CHANGE IN FLOOR

FINISH LOCATION

THE ARROWS POINT TO

UNLESS NOTED OTHERWISE

**TRANSPARENT** 

THICK

TOILET

TREATED

TYPICAL

UTILITY

WITH

WOOD

**WINDOW** 

**WITHOUT** 

**WEIGHT** 

**ABBREVIATIONS:** 

ALTERNATE

APPLIANCE

AUTOMATIC

**BUILDING** 

**BLOCKING** 

CABINET

CARPET

CERAMIC

CEILING

COVER

DOUBLE

DETAIL

DIAMETER

**DIFFUSER** 

**DIMENSION** 

DISPENSER

DISCONNECT

**DISHWASHER** 

EXTERIOR INSULATED

**FINISH SYSTEM** 

**ELASTOMERIC** 

ENGINEER(ED)

**ELECTRICAL** 

**EQUIPMENT** 

**EXPANSION JOINT** 

**EXISTING** 

**EXTERIOR** 

**EQUAL** 

DRAWER

DIVISION

**DOWN** 

DOOR

**DEPARTMENT** 

**CENTER LIN** 

CONCRETE

**CONTINUOS** 

CONTRACTOR

CONCRETE MASONRY UNIT

**BOARD** 

ARCHITECT(URAL)

APPL

ARCH

BLDG

BLKG

CPT

CER

CLG

CONT

CONTR

COV

CMU

DBL

DET

DIA

DIFF

DIV

DN

DR

DSCON

DWR

**EIFS** 

ENGR

**EQUIP** 

**EXIST** 

**ABOVE FINISH FLOOR** 

FAB

FD

FIN

**FPLC** 

FRMG

FXD

**FXTR** 

FLR

GΑ

GC

GYP

HD

HOR

HVAC

INFO

INSUL

INT

K/S

LAV

LVR

MAX

MFD

MFR

**MECH** 

**MEMB** 

MEZZ

MIN

MISC

**MLWK** 

MTD

**FURN** 

**FABRICATION** 

FLOOR DRAIN

FIREPLACE

FRAMING

FIRE RAT(ED)(ING)

GENERAL CONTRACTOR

HEATING, VENTILATING

& AIR CONDITIONING

FINISH

DIXED

**FIXTURE** 

GAUGE

**GYPSUM** 

HEAD

HORIZONTAL

INFORMATION

INSULATION

INTERIOR

KITCHEN

KNEE SPACE

LAVATORY

LINEAR FOOT (FEET)

POUND

LIGHT

LOUVER

MAXIMUM

MANUFACTURED

**MANUFACTURER** 

**MISCELLANEOUS** 

MECHANICAL

MEMBRANE

MEZZANINE

MINIMUM

**MILLWORK** 

MOUNTED

MICROWAVE

FLOOR(ING)

FURNITURE

1.	2.COMPLY WITH ALL CODES, LAWS, ORDINANCES, RULES AND
	REGUALTIONS OF PUBLIC AUTHORITIES GOVERNING THIS WORK.
2.	OBTAIN AND PAY FOR PERMITS AND INSPECTIONS AS REQUIRED BY

THE ARCHITECT FOR REVIEW AND APPROVAL PRIOR TO PURCHASE,

5. COORDINATE WORK WITH THE OWNER, INCLUDING SCHEDULING TIME AND LOCATIONS FOR DELIVERIES, PROPERTY AND/OR BUILDING ACCESS, USE OF SERVICES AND FACILITIES, AND USE OF ELEVATORS. MINIMIZE DISTURBANCE OF BUILDING FUNCTIONS AND

6. WORK NOTED "BY OTHERS" OR "NIC" WILL BE PROVIDED BY THE OWNER UNDER A SEPARATE CONTRACT. INCLUDE SCHEDULE COORDINATE WITH OWNER TO ENSURE ORDERLY SEQUENCE OF INSTALLATION OF ALL WORK, INCLUDING "NIC" AND "BY OTHERS"

7. COORDINATE THE INSTALLATION OF TELECOMMUNICATIONS, DATA

8. MAINTAIN EXITS, EXIT LIGHTING, FIRE PROTECTIVE DEVICES, AND ALARMS IN CONFORMANCE WITH APPLICABLE CODES AND ORDINANCES.

10. MAINTAIN WORK AREAS SECURE AND LOCKABLE DURING CONSTRUCTION. COORDINATE WITH TENANT AND LANDLORD TO

11. DO NOT SCALE DRAWINGS. WRITTEN DIMENSIONS GOVERN.

FACE TO FINISH FACE, UNLESS OTHERWISE NOTED. MAINTAIN

ATTACHED OR MOUNTED TO WALLS OR CEILINGS. 14. UNDERCUT DOORS TO CLEAR TOP OF FLOOR FINISHES BY 1/4", UNLESS

## **GENERAL NOTES:**

- 3. REVIEW THESE DOCUMENTS, VERIFY DIMENSIONS AND EXISTING CONDITIONS AND CONFIRM THAT THE WORK IS BUILDABLE AS SHOWN. REPORT ANY CONFLICTS OR OMMISSIONS TO THE ARCHITECT FOR CLARIFICATION PRIOR TO ORDERING ANY
- 9. PROTECT WORK AND SURROUNDING AREAS FROM DAMAGE.
- ENSURE SECURITY.
- 12. PARTITIONS, FLOORS AND CEILINGS ARE DIMENSIONED FROM FINISH

- FABRICATION OR INSTALLATION. OCCUPANTS.
- AND SECURITY SYSTEMS WITH THE PROPER PARTIES.
- CONSULT THE ARCHITECT IN CASE OF CONFLICT.
- 13. COORDINATE AND PROVIDE BACKING FOR MILLWORK AND ITEMS
- 15. ENSURE SURFACES TO RECEIVE FINISHES ARE CLEAN, TRUE, AND FREE OF IRREGULARITIES. DO NOT PROCEED WITH WORK UNTIL UNSATISFACTORY CONDITIONS HAVE BEEN CORRECTED.
- 16. PROVIDE STRAIGHT, FLUSH RESILIENT BASE AT CARPETED AREAS, AND COVED, TOP SET RESILIENT BASE AT RESILIENT FLOORING, UNLESS OTHERWISE NOTED.

# THE AUTHORITIES GOVERNING THIS WORK.

- MATERIALS OR PERFORMING ANY WORK IN QUESTION
- 4. SUBMIT REQUESTS FOR SUBSTITUTIONS, REVISIONS, OR CHANGES TO
- REQUIREMENTS IN THE CONSTRUCTION PROGRESS SCHEDULE AND

- DIMENSIONS MARKED "CLEAR". ALLOW FOR THICKNESS OF FINISHES.
- OTHERWISE NOTED.


# VICINITY MAP

Civil & Structural Engineer:

Marsh / Jalayer & Associates

8910 Bell Flower, Houston, TX 77063

Tel: 713 . 782 2282

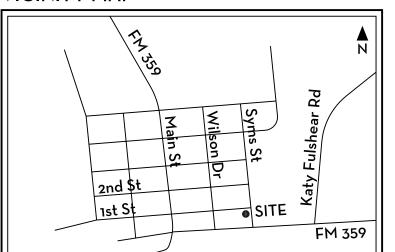

## Codes:

- 2009 International Building Code.
- 2009 National Electric Code.
- 2009 International Fire Code.
- City of Fulshear Codes and Ordinances.
- 2009 International Energy Code.
- 2012 Texas Accessibility Standards (TAS): TAS standards closely follow the Americans with Disabilities Act Accessibility Guidelines (ADAAG), and have been approved by the Departmet of Justice (DOJ).

Note: all contractors working in the city of Fulshear must register with the city before performing any work.

# **INDEX OF DRAWINGS**

Civil DRAINAGE C-1

Architect:

Kashou Architecture, Inc.

20710 Shadow Mill Ct

Katy, Texas 77450

Tel: 713 . 965 4470

Fulshear Clinic

Shell Building

8502 Syms Street, Fulshear TX 77441

C-2 DRAINAGE DETAILS

**Architectural** 

Ao.o COVER PAGE. VICINITY MAP, LEGEND, CODE ANALYSIS A1.1 SITE PLAN

Electrical & Plumbing Engineer:

William K Hall & Co

**Consulting Engineers** 

1901 Long Prairie Rd, Flower Mound, TX 75022

Tel: 214 . 681 2179

LANDSCAPING PLAN SITE DETAILS

A1.2 SLAB PLAN

FIRST FLOOR PLAN DOOR SCHEDULE WINDOW SCHEDULE

A2.2 SECOND FLOOR PLAN FINISH PLANS

**FINISH LEGEND** A3.1 REFLECTED CEILING PLANS

A4.1 ROOF PLAN **A5.1 EXTERIOR ELEVATIONS** 

**ELEVATION DETAILS** A6.1 BUILDING SECTIONS

**DETAILS** A7.1 DETAILS

A7.2 DETAILS A8.1 STAIR PLANS & DETAILS

**WALL ASSEMBLIES ELEVATOR PLANS & DETAILS** 

Structural: S-1

FOUNDATION FOUNDATION DETAILS S-2 FIRST FLOOR FRAMING

SECOND FLOOR FRAMING ROOF FRAMING S-5

DETAILS Electrical / Plumbing

EP-1 ELECTRICAL / PLUMBING SITE PLAN ELECTRICAL LIGHTING PLANS ELECTRICAL POWER PLANS

**ELECTRICAL PANELS & RISER DIAGRAM ELECTRICAL SPECIFICATIONS** 

PLUMBING PLANS P-2

PLUMBING RISER PLUMBING SPECIFICATIONS & DETAILS

Kashou Shawn Kashou, Architect

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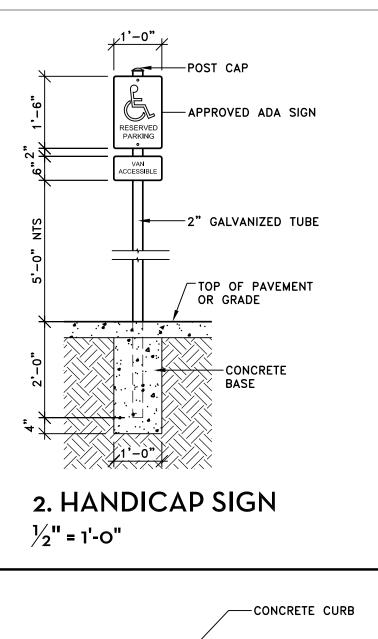
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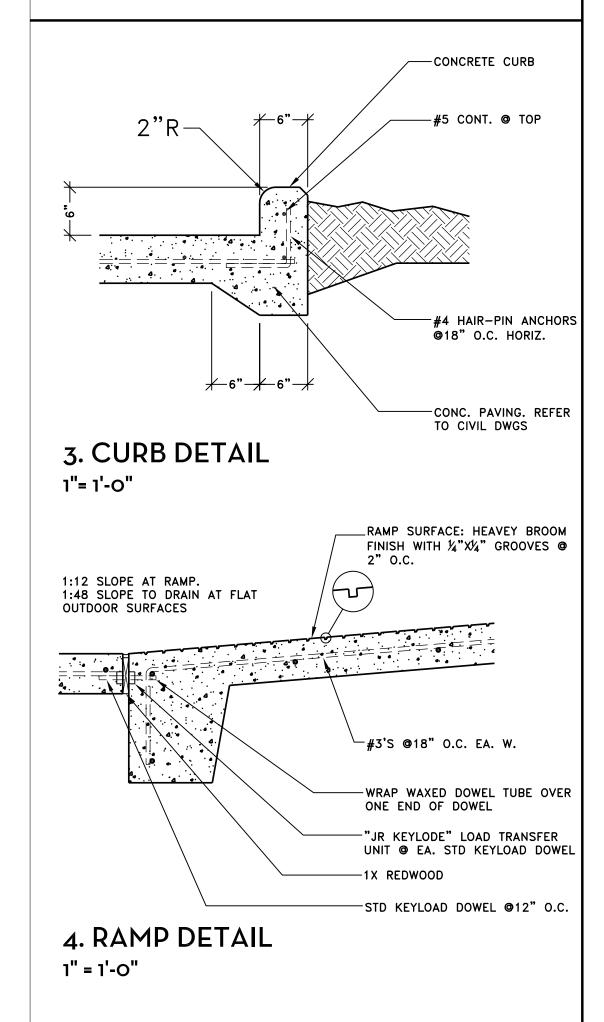
Project No.

Dwg. Name Site Plan


Dwg. No.







 $\frac{3}{16}$ " = 1'-0"

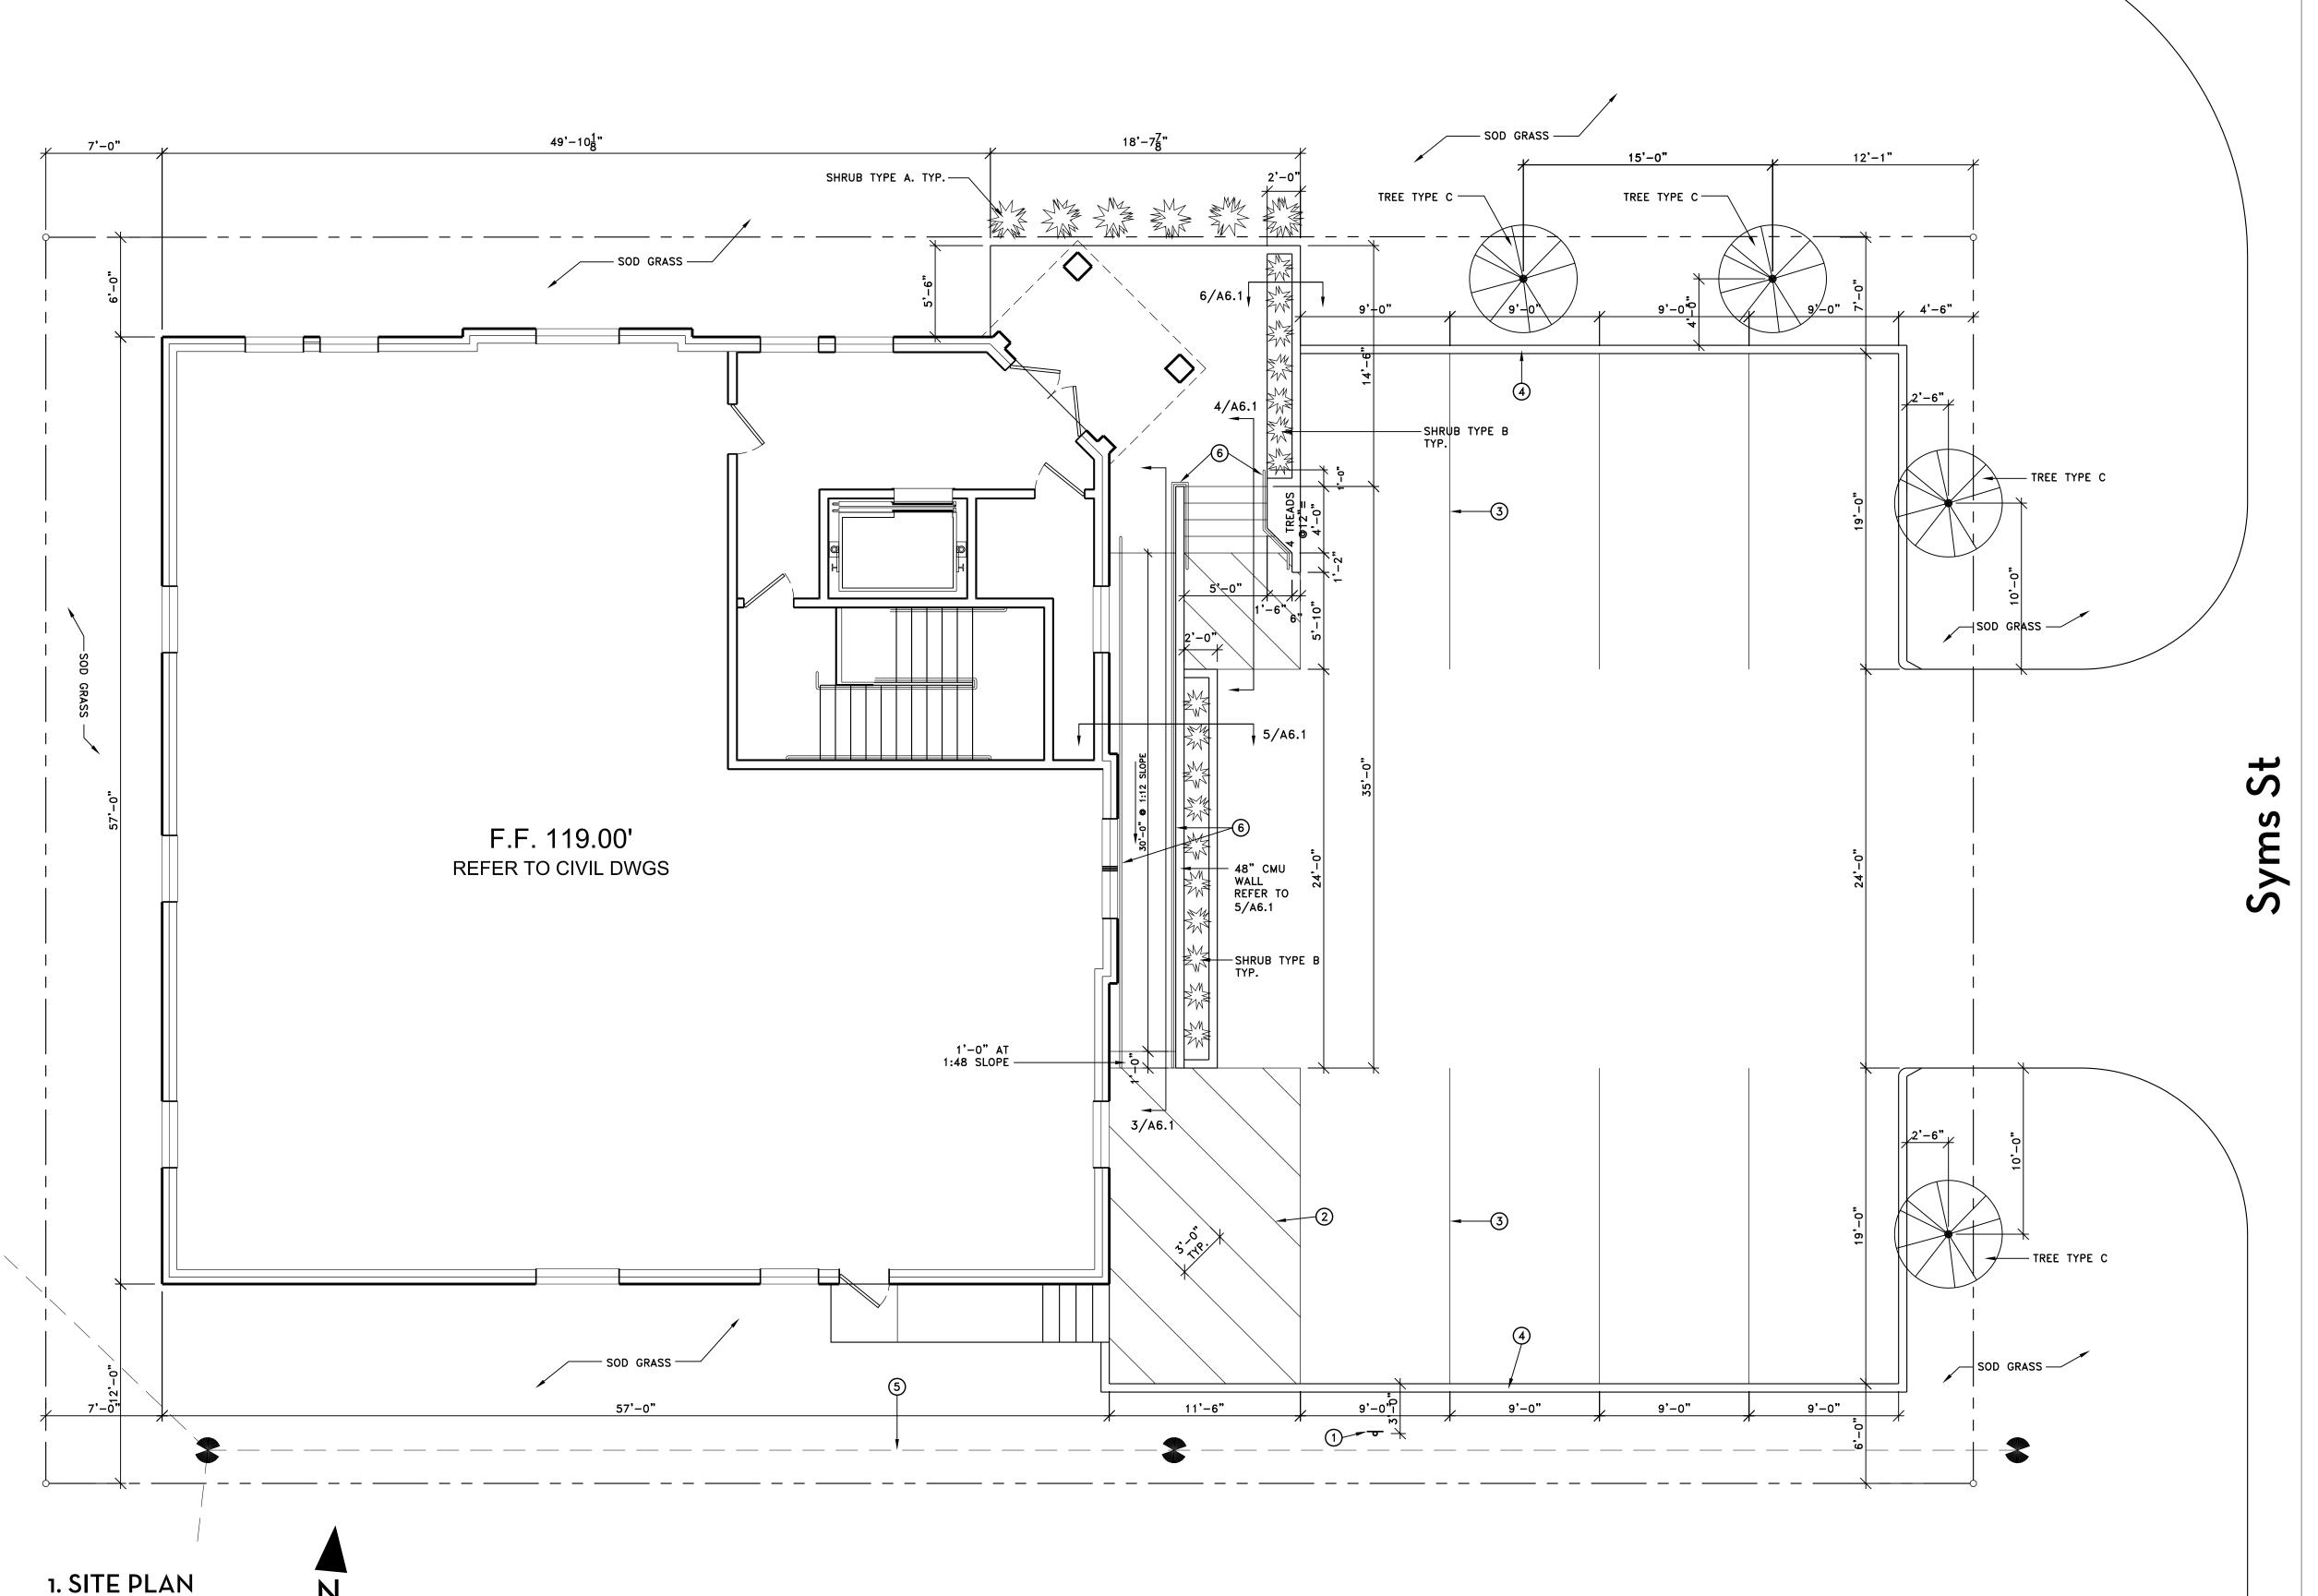

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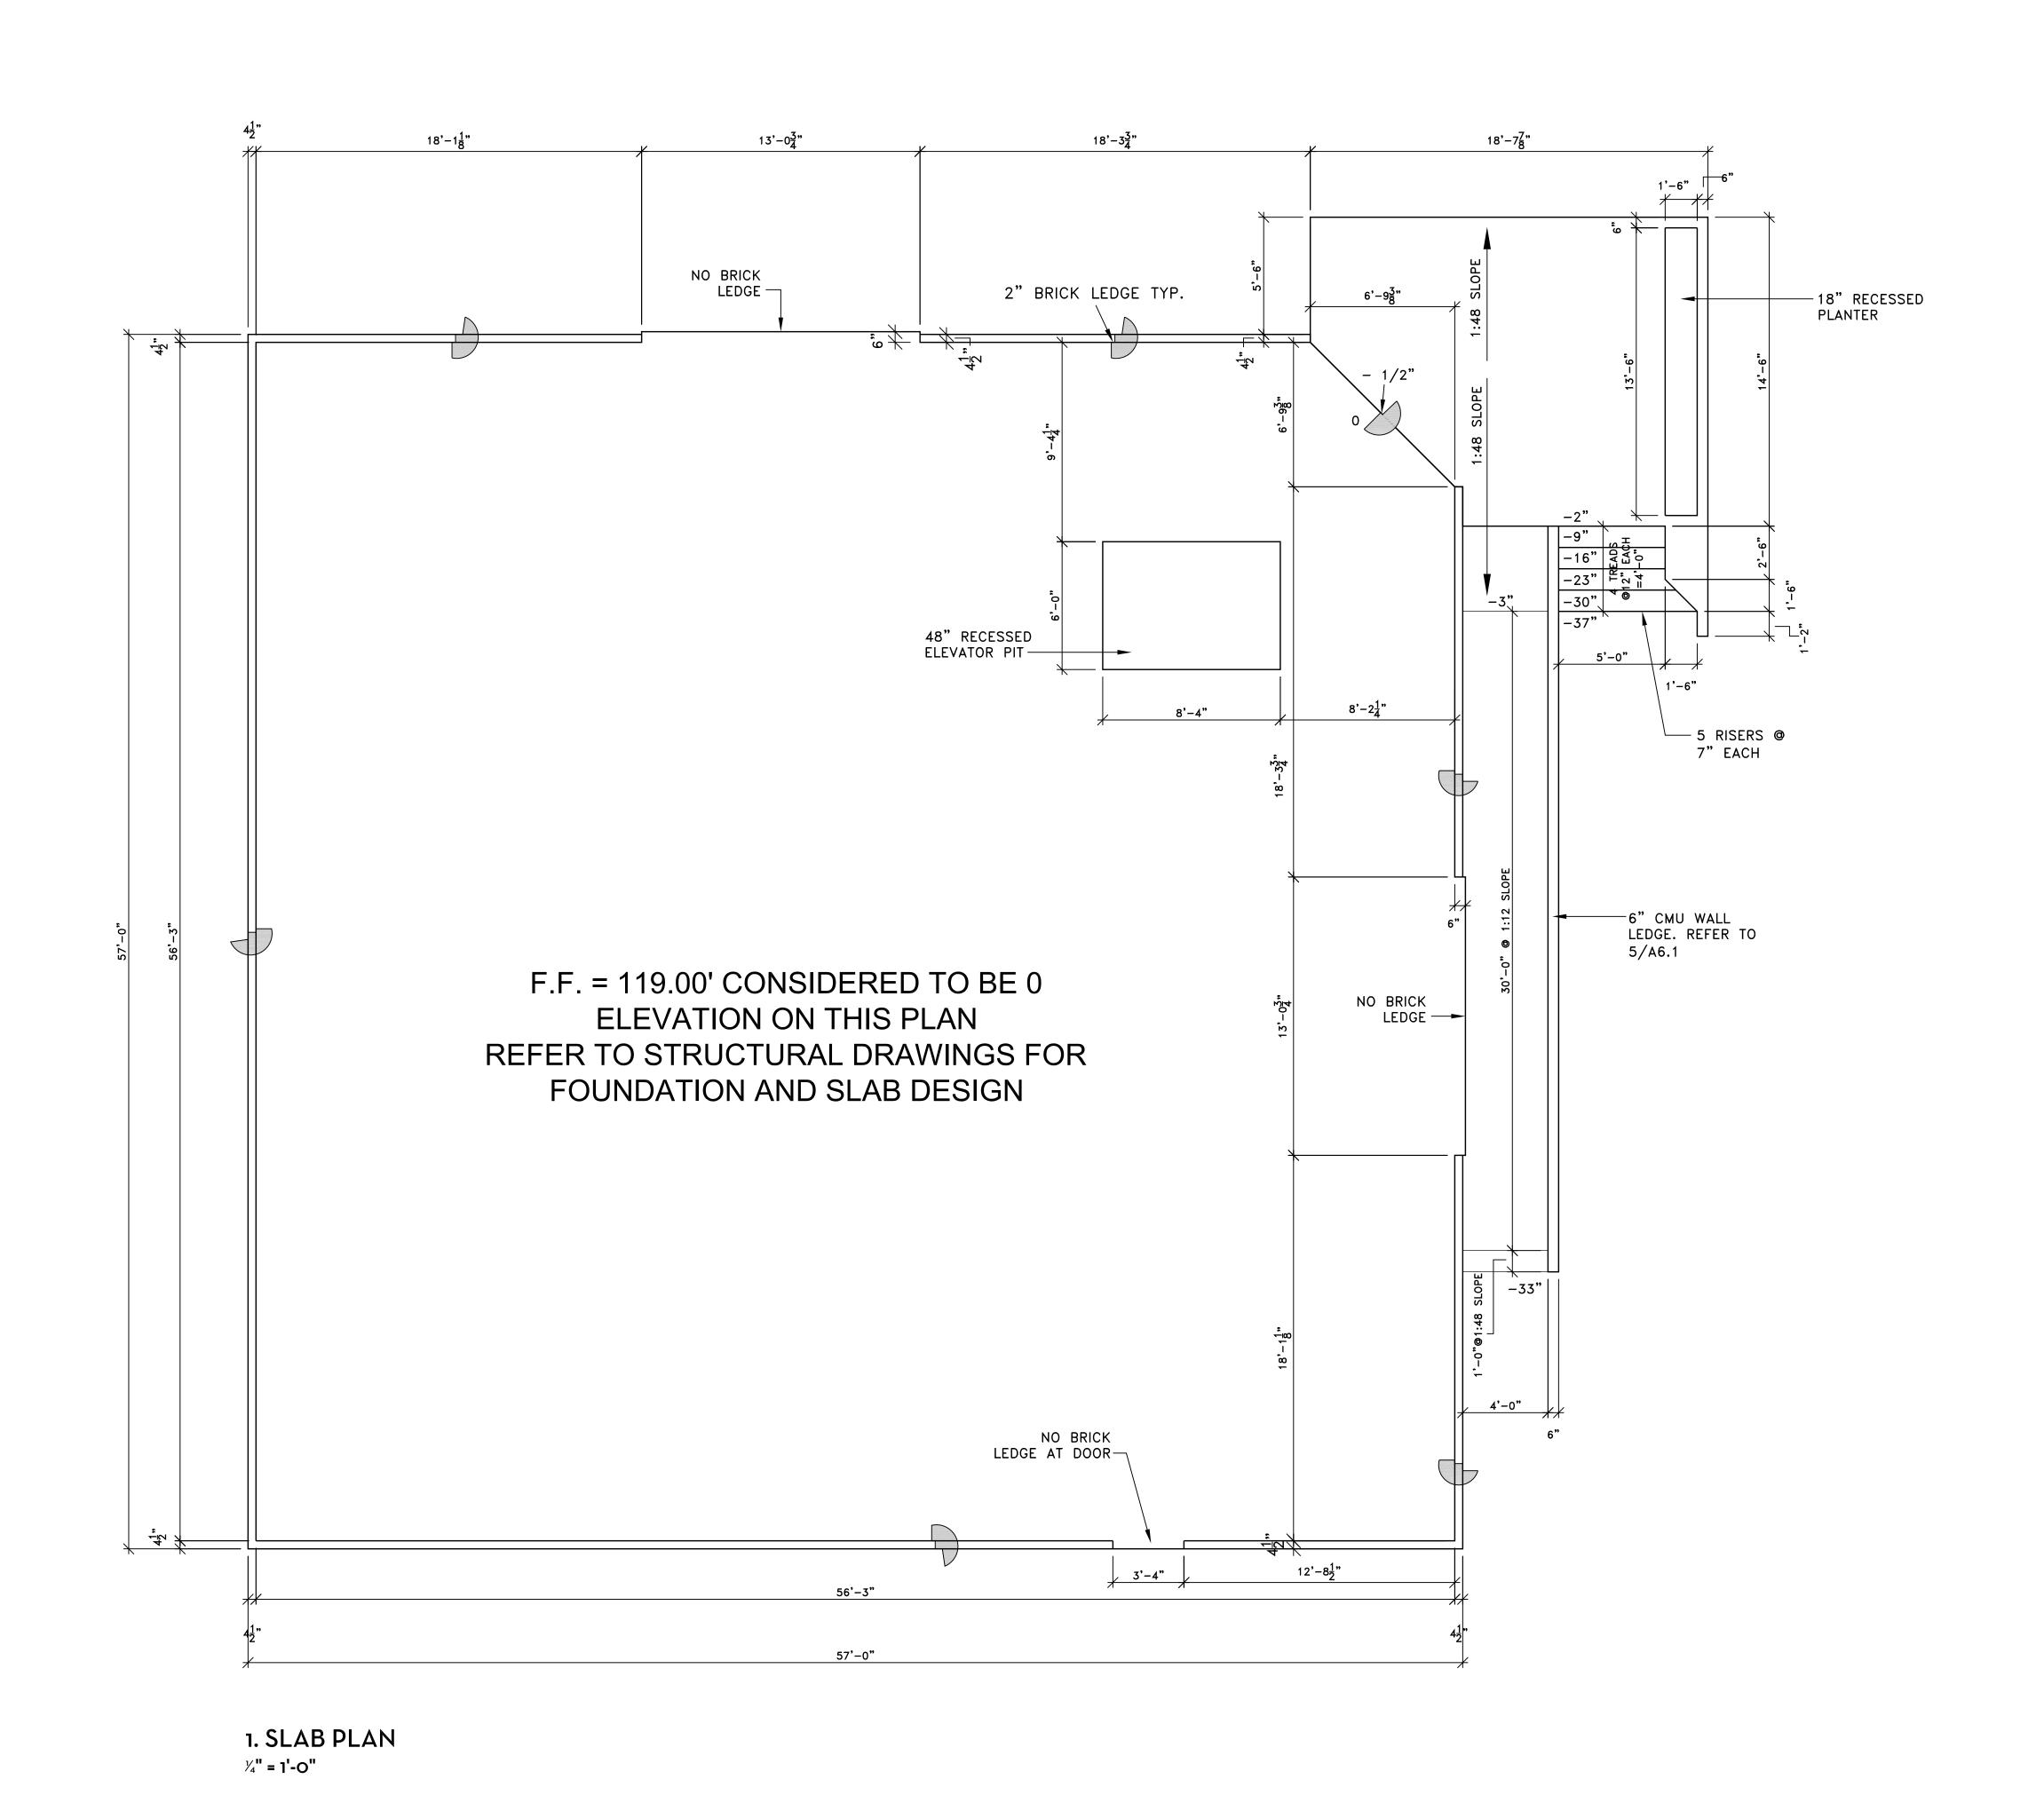
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Project No.

Dwg. Name Slab Plan



Fulshear Clinic Shell Building

ASHOU

architecture

wn Kashou, Architect

Shawn Kashou, Architect 20710 Shadow Mill Ct Katy, Texas 77450 Tel: 713 . 965 4470

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Project No.

Dwg. Name

First Floor Plan

Dwg. No.

**A2.**7



KASHOU

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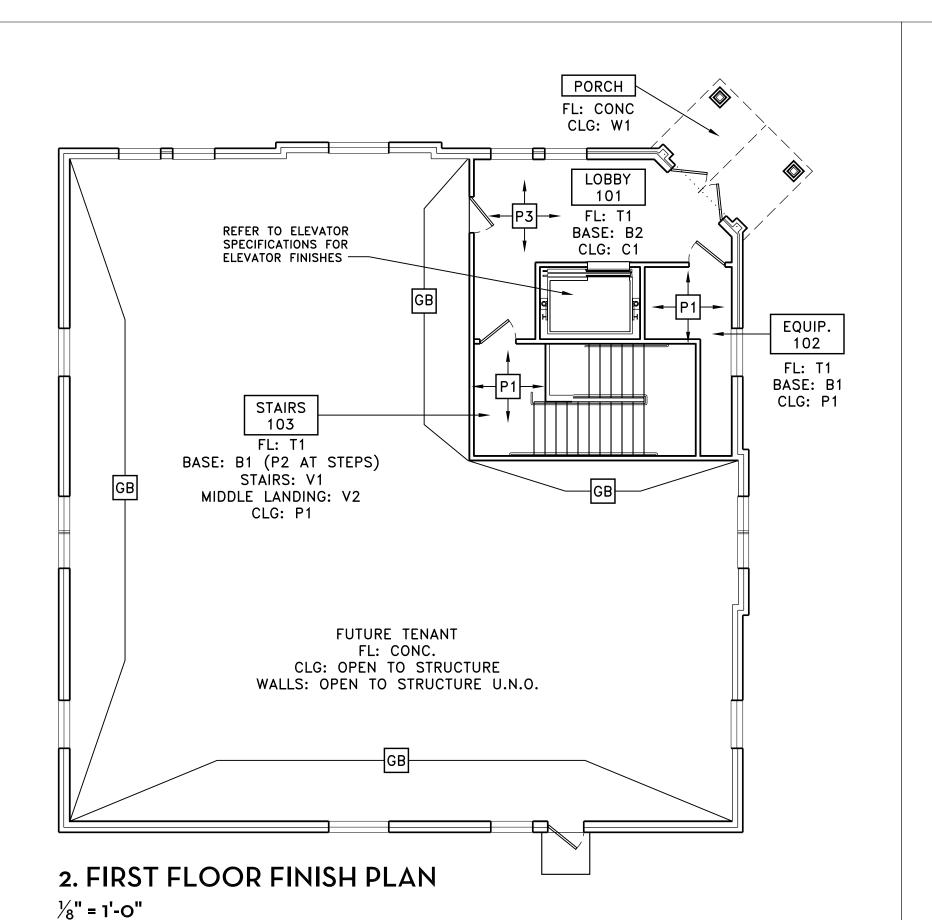
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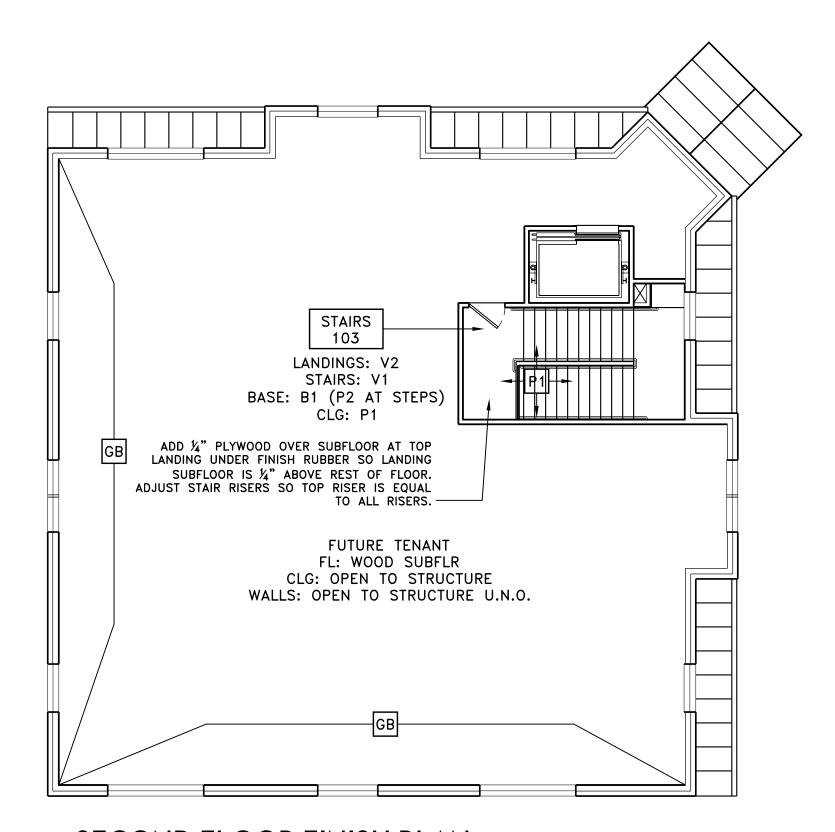
Project No.

Dwg. Name Second Floor

Plan. Finish Plans

Dwg. No.





## 3. SECOND FLOOR FINISH PLAN ½" = 1'-0"

### FINISH LEGEND DO NOT INSTALL FINISHES UNTIL COLORS ARE SELECTED AND SAMPLES ARE APPROVED BY ARCHITECT PER SPECIFICATIONS. FINISH DESCRIPTION COLOR NOTES T1 PORCELAIN TILE SAND | ELEGANZA DIGISLATE RUSTIC PORCELAIN. SAND COLOR. 18"X18". CHOCOLATE BROWN GROUT. B1 VINYL BASE TBD ROPPE PINNACLE 6" NO TOE VINYL BASE. COLOR TO BE SELECTED BY ARCHITECT. B2 WOOD BASE STAIN 6" STAINED WOOD BASE. PROFILE AND COLOR TO BE SELECTED BY ARCHITECT. P1 | PAINTED GYP. BD. TBD PRIMER & PAINT. P2 PAINTED WOOD TBD GLOSS ENAMEL PAINTED WOOD BASE TRIM AT STEPS. COLOR TBD. P3 PAINTED GYP. BD. TBD PRIMER & PAINT WITH SPECIFIED TEXTURE. C1 | CEILING TILE WHITE 24"X 24" CEILING TILE. ARMSTRONG DUNE BEVELED TEGULAR #1775, FINE TEXTURE, WHITE. PRELUDE EXPOSED T 9/16" GRID, WHITE. CONC CONCRETE GRAY | FINE TEXTURE FINISH. W1 CEDAR WOOD STAIN | SMOOTH FINISHED CEDAR WOOD PLANKS. STAIN COLOR TO BE SELECTED BY ARCHITECT. GB GYP. BD. GYPSUM BD. TAPE FLOAT AND SEAL PER WALL RATING REQUIREMENT. DO NOT PAINT. V1 RESILIENT RUBBER | TBD | ROPPE RESILIENT RUBBER TREADS AND RUBBER TOE BASE RISERS. V2 RESILIENT RUBBER | TBD | ROPPE RESILIENT RUBBER LANDINGS TO MATCH STAIR TREADS.

# $_{\nu}$ 2'-9 $\frac{7}{8}$ " $_{\nu}$ 3'-7" $_{\nu}$ 2'-9 $\frac{7}{8}$ " 18'-1<mark>1</mark>" $12'-11\frac{3}{4}$ " 15'−8<mark>1</mark>" 9'-6<mark>1</mark>" 6'-5<del>7</del>" 7'-2<mark>1</mark>" 6'-5<sup>7</sup> 8'-6<sup>1</sup> 8'-7" 2/A6.1 (06) 05) 5'-6" ELEVATOR 1/A6.1 1'-6" STAIRS 103 2/A8.1 FUTURE TENANT <u>√ 3'−6"</u> 07) 05) 06) 8'-7" 13'-7" 53'-2"

54'-0"

DIMENSIONS ARE TO FRAMING. U.N.O.

1. SECOND FLOOR PLAN

½" = 1'-0"

**PLAN GENERAL NOTES:** 

PLAN KEYED NOTES:

1. 30X48 REFUGE AREA.

3. GYP. BD. SILL.

1. REFER TO 8/A8.1 FOR WALL ASSEMBLY TYPES.

OUSIDE OF VENT SHAFT AND FIRE SEAL.

WALLS TO BE INSULATED BUT NOT COVERED WITH GYP. BD.

2. EXTERIOR WALLS MARKED TYPE B1 TO BE FINISHED WITH TYPE X GYP. BD. TO DECK TO COMPLY WITH RATED WALL TYPE B1. OTHER NON RATED EXTRIOR

2. VENT SHAFT FROM EQUIPMENT ROOM TO ATTIC. INSTALL ELEVATOR FIRE ENCLOSURE FIRST, THEN INSTALL SHAFT WITH 2 LAYERS TYPE X GYP. BD. ON



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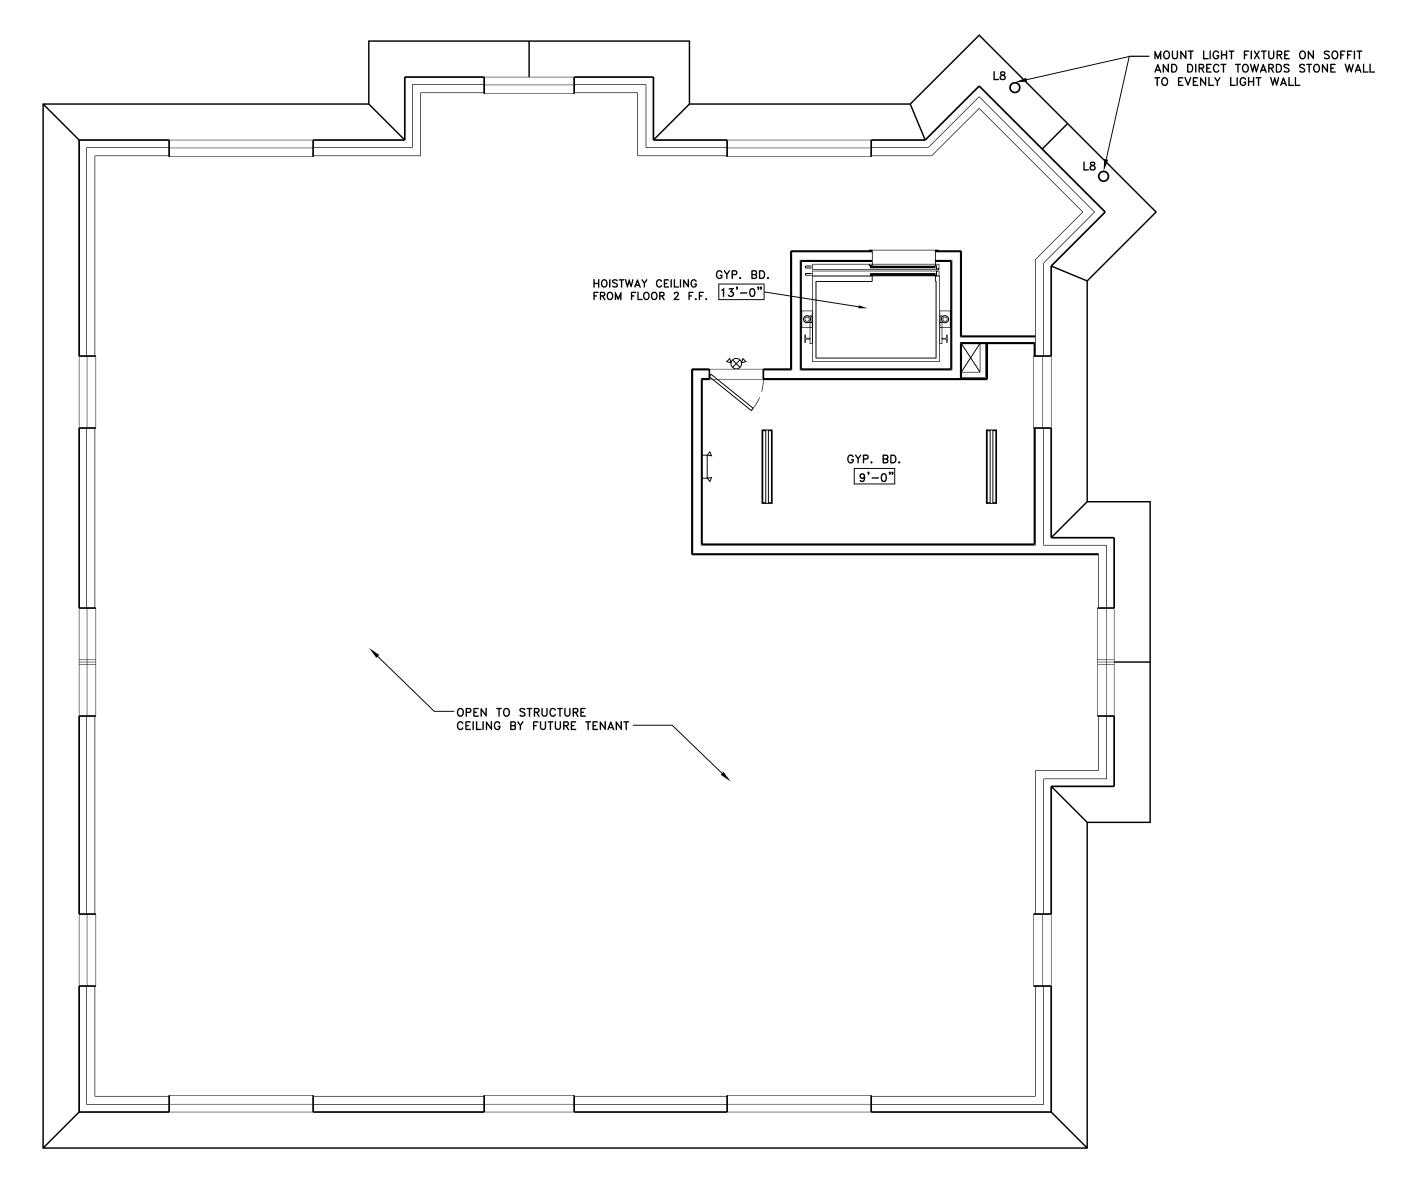
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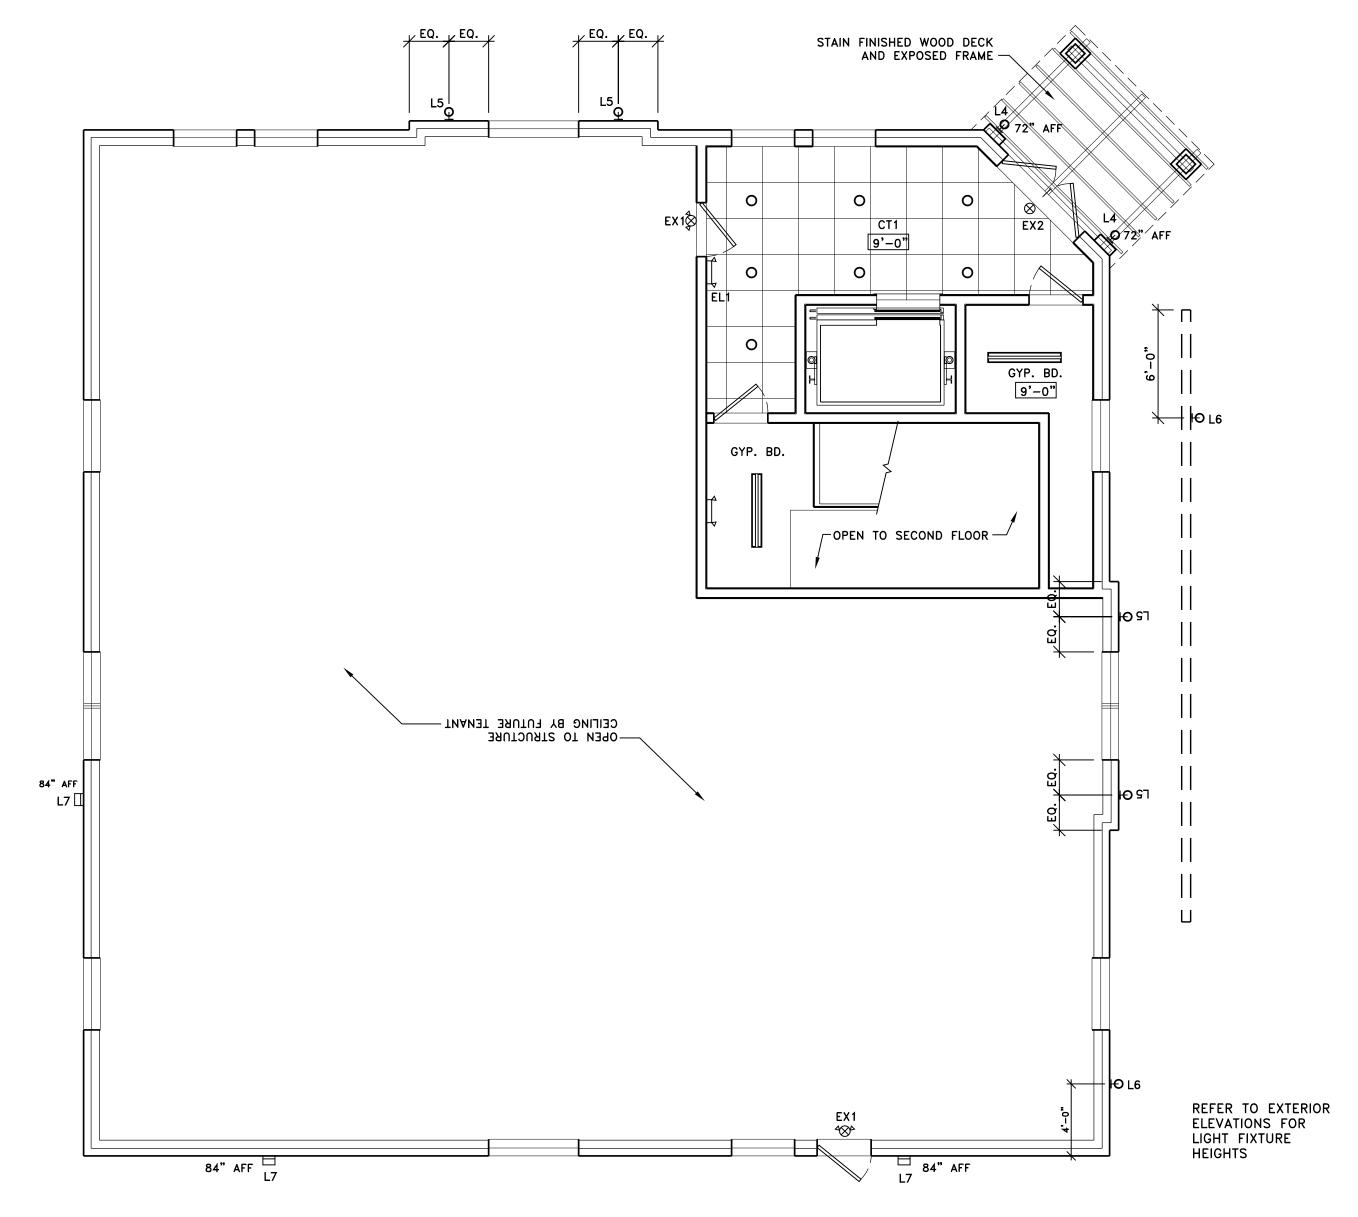
Reflected Ceiling Plans

Dwg. No.

**A3.**1



2. SECOND FLOOR REFLECTED CEILING PLAN
3/16" = 1'-0"



1. FIRST FLOOR REFLECTED CEILING PLAN
3/16" = 1'-0"

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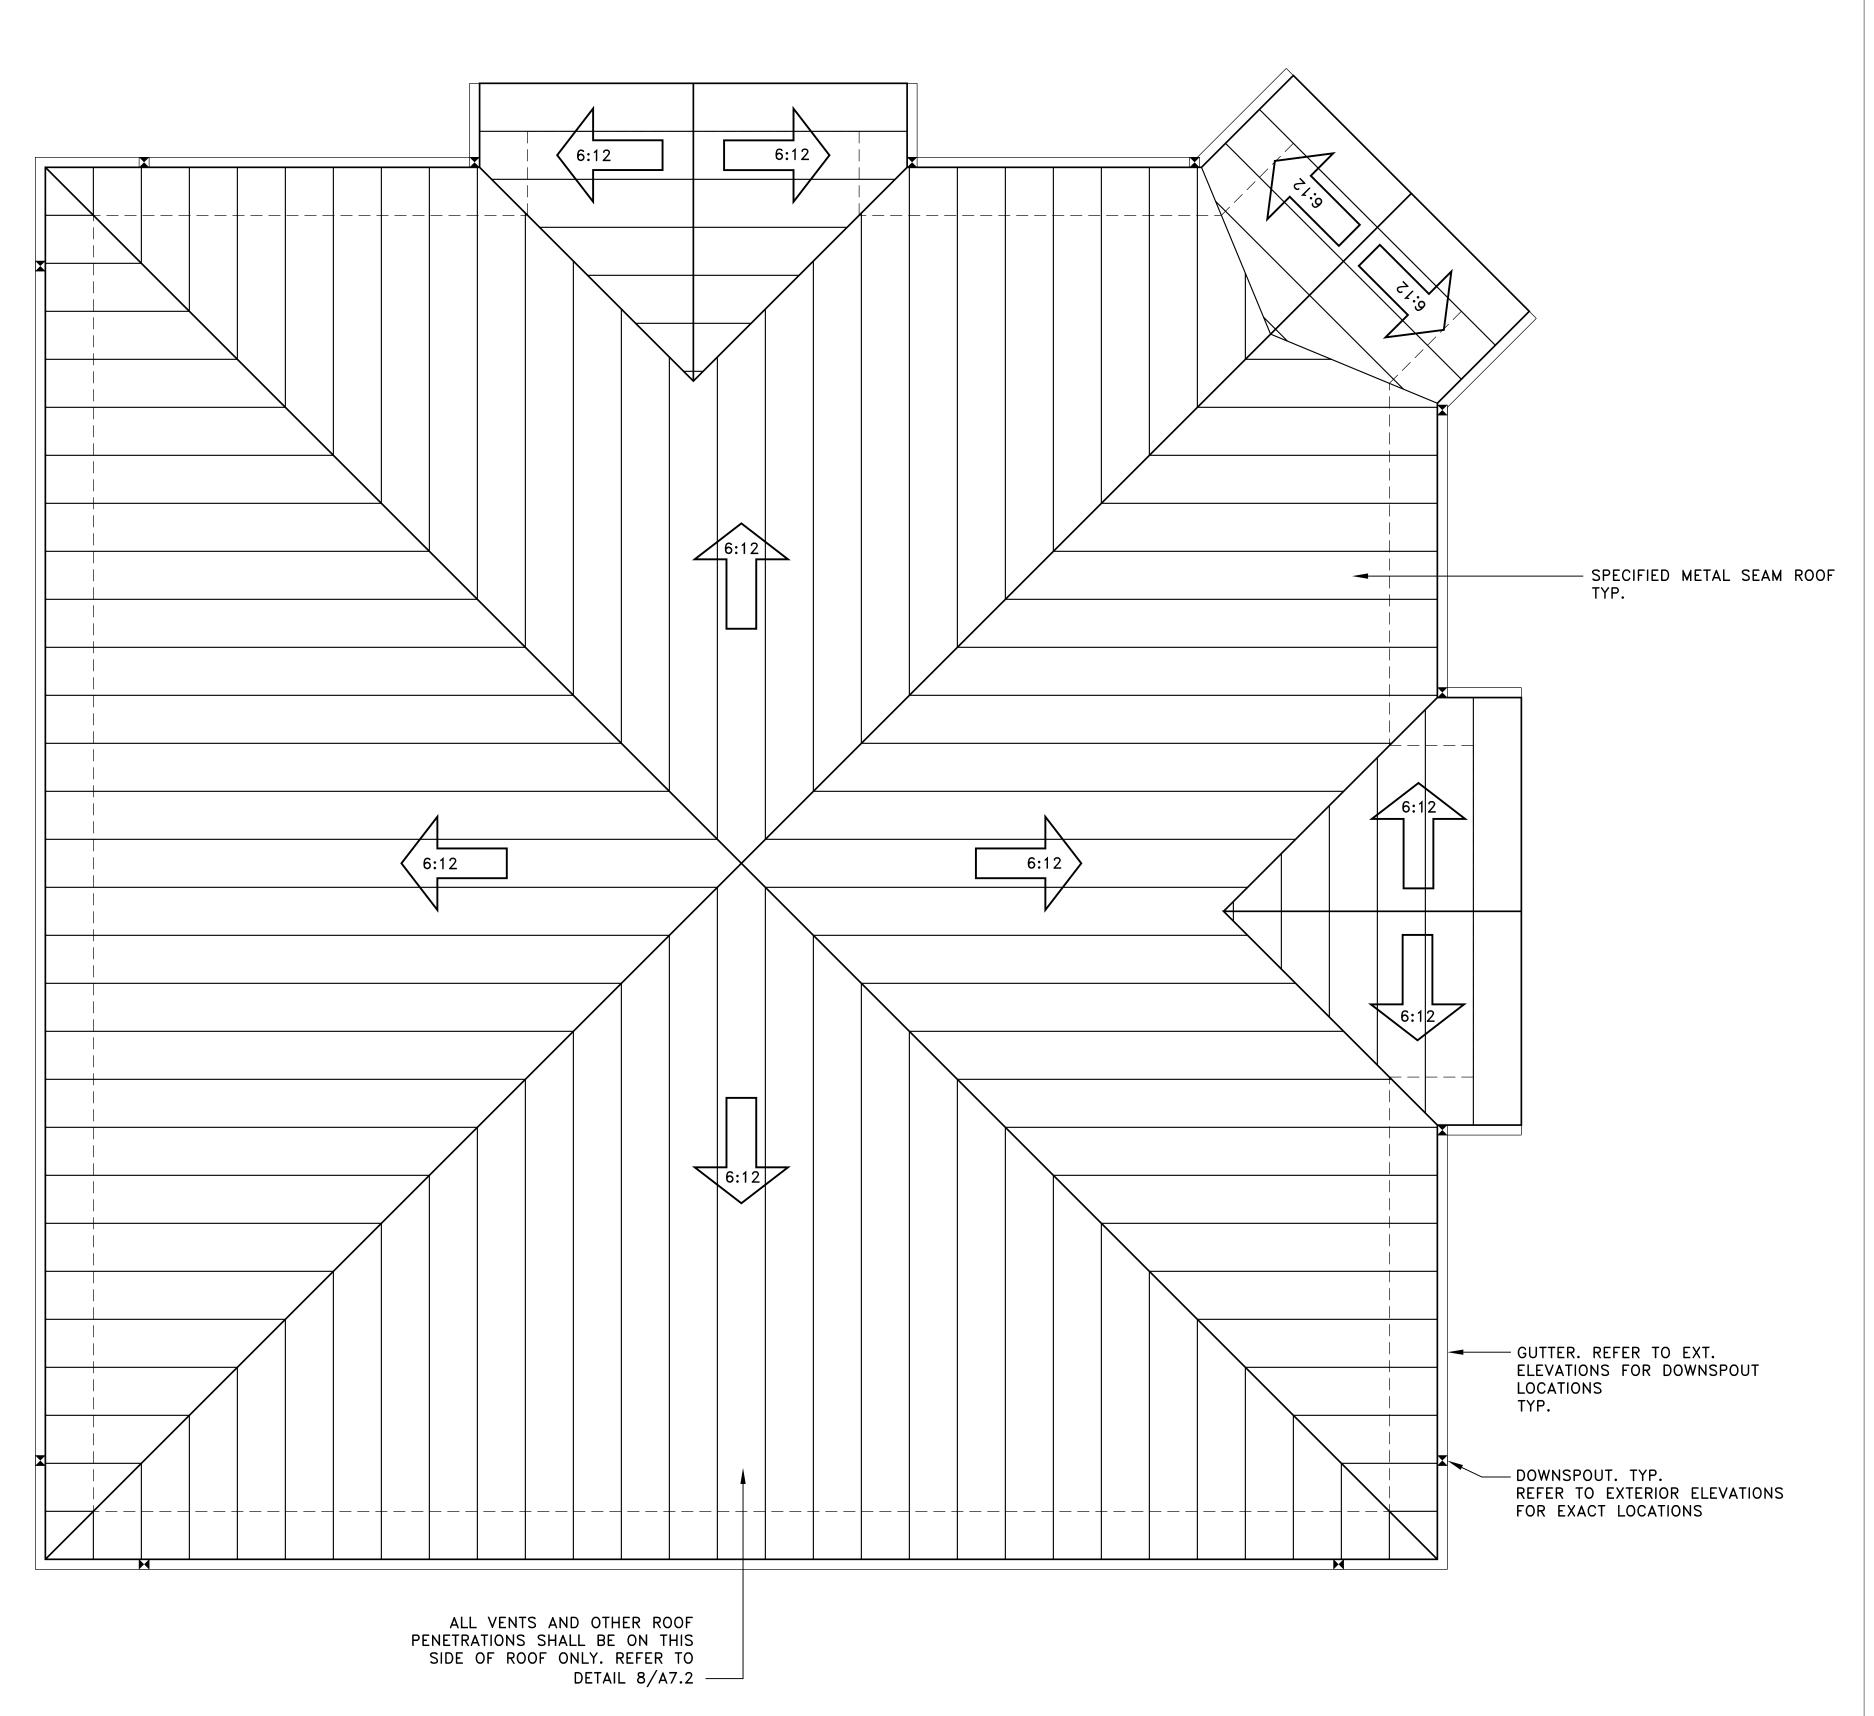
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Project No.

Dwg. Name

**Roof Plan** 

Dwg. No.



1. ROOF PLAN ½" = 1'-0"



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KASHOU

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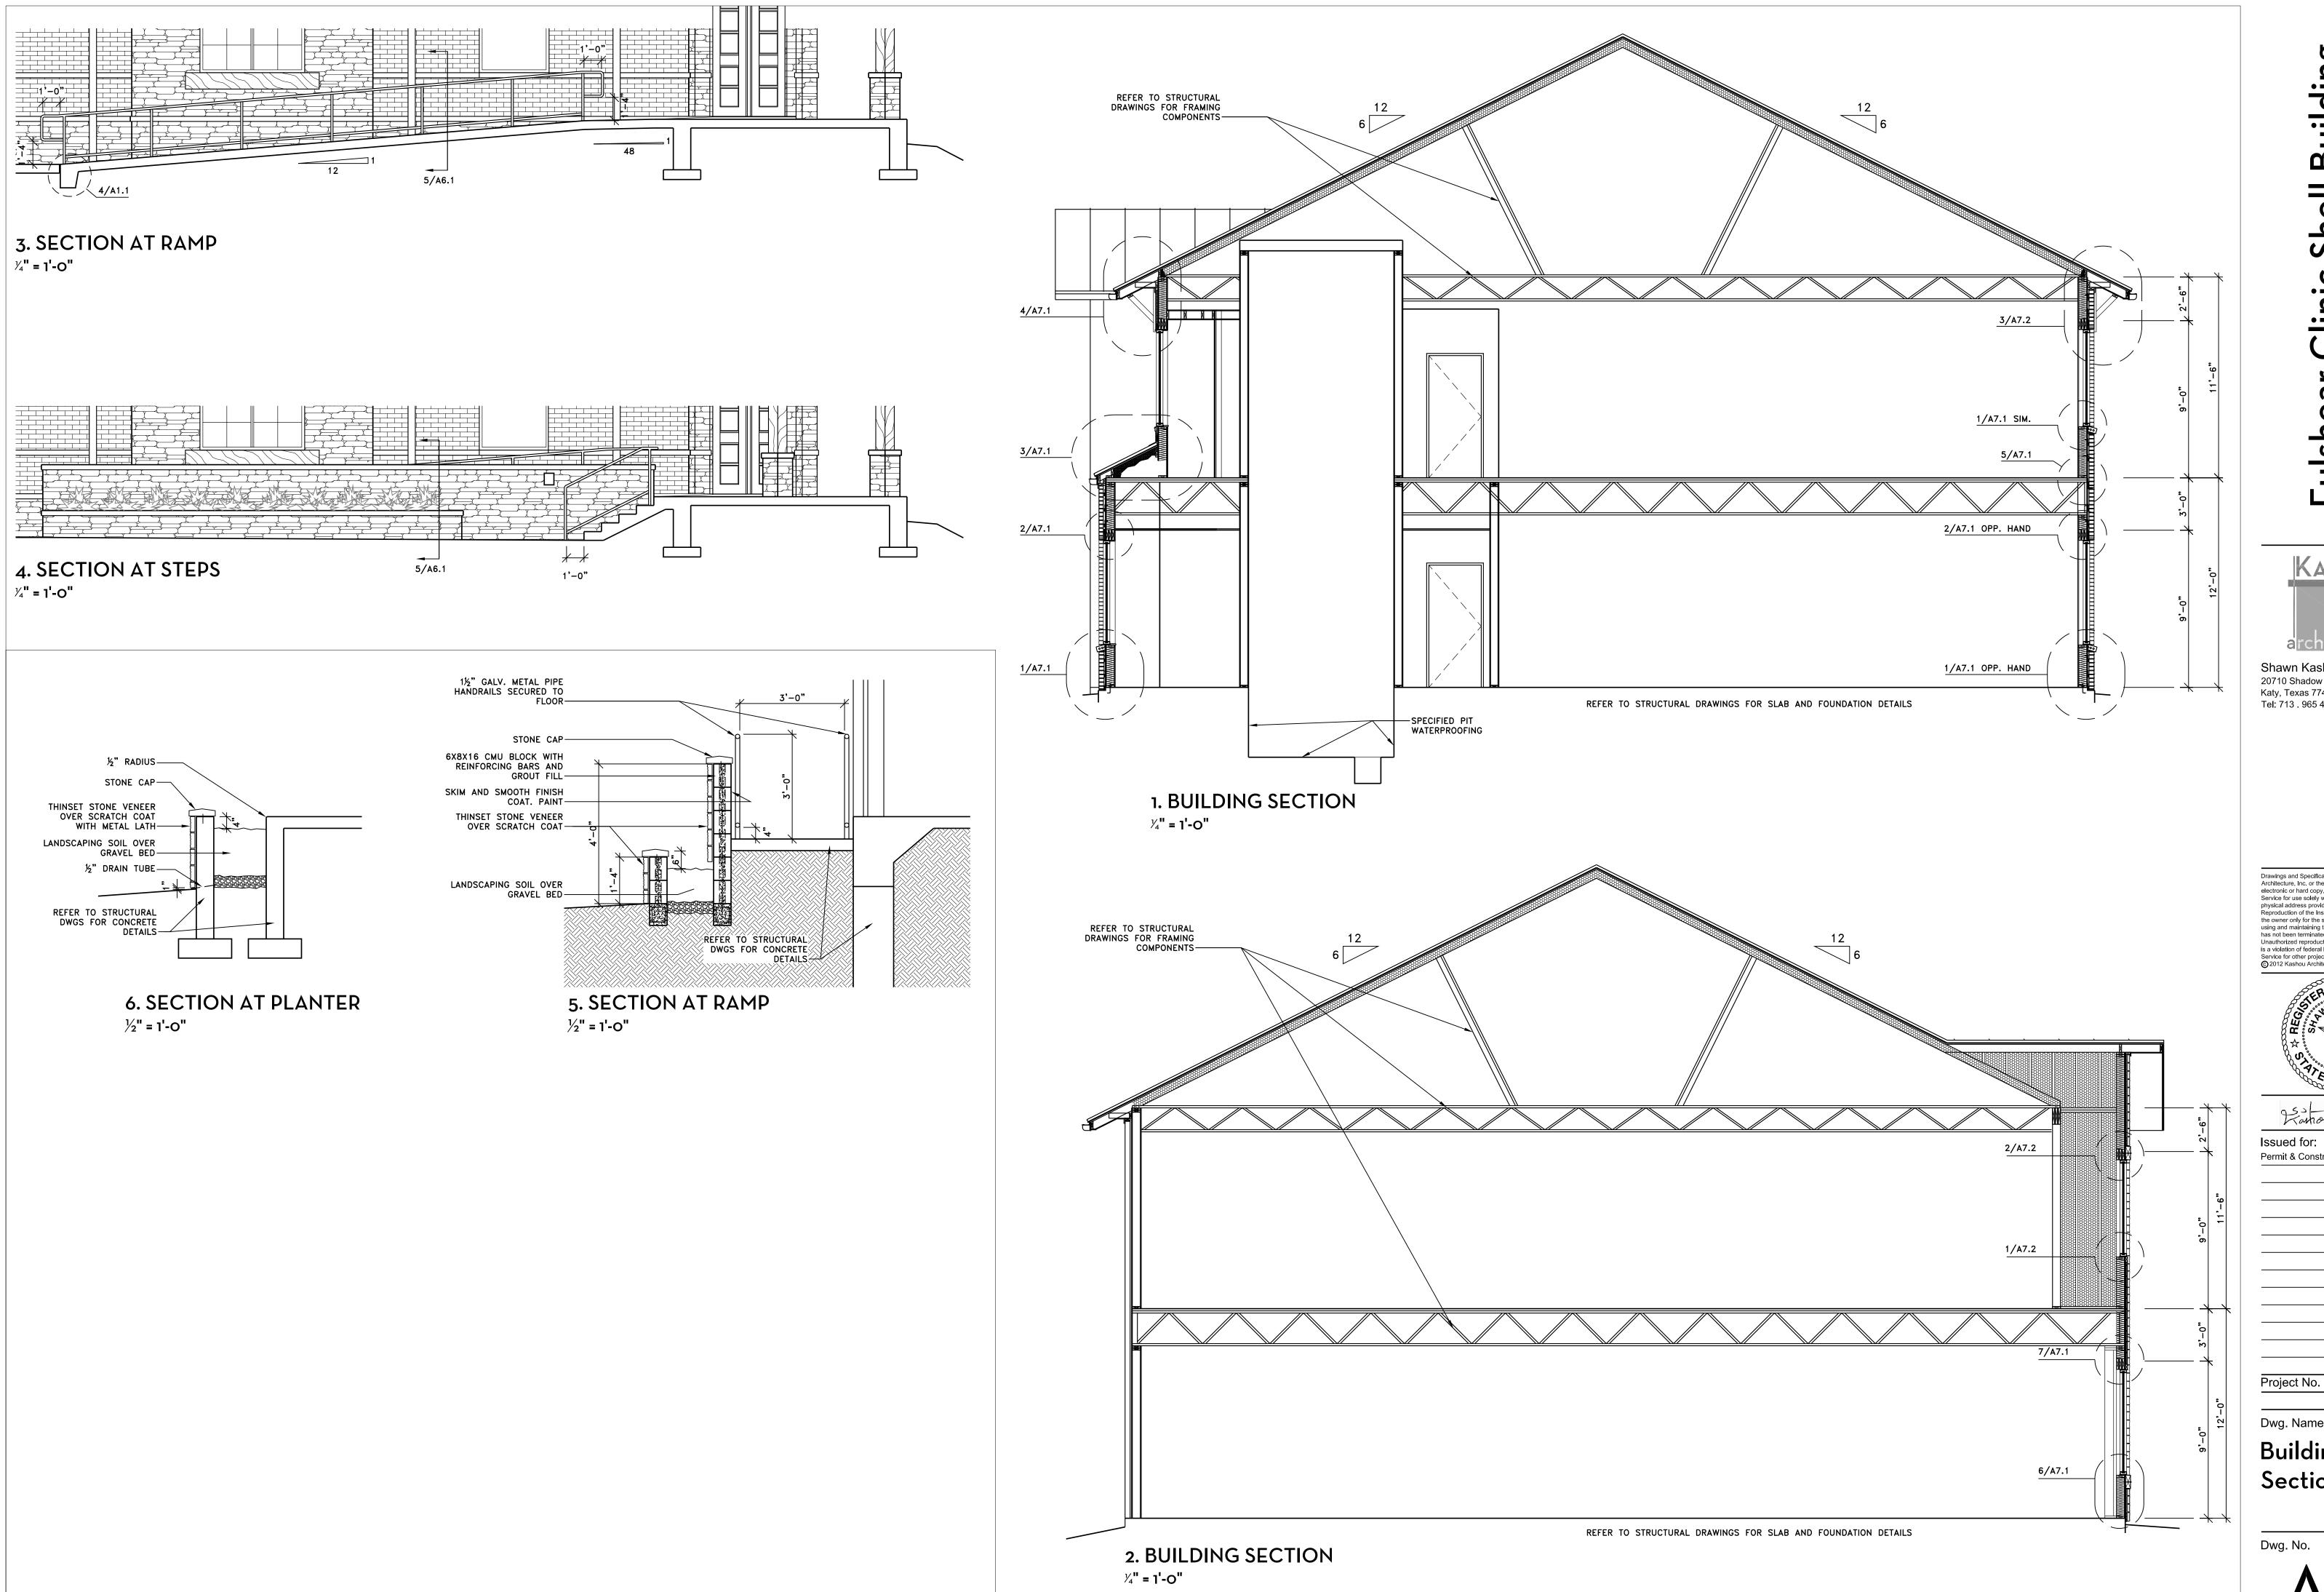
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**Exterior Elevations** 



uilding 

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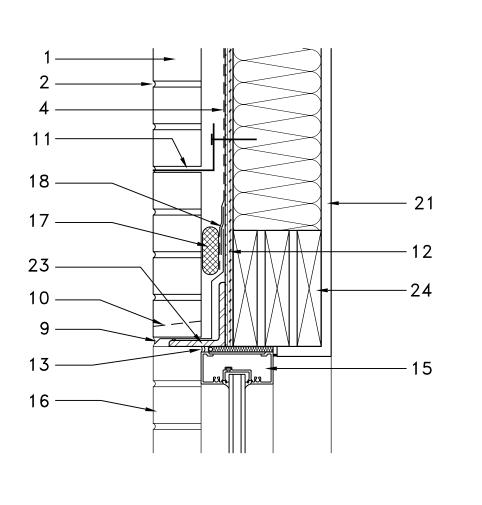
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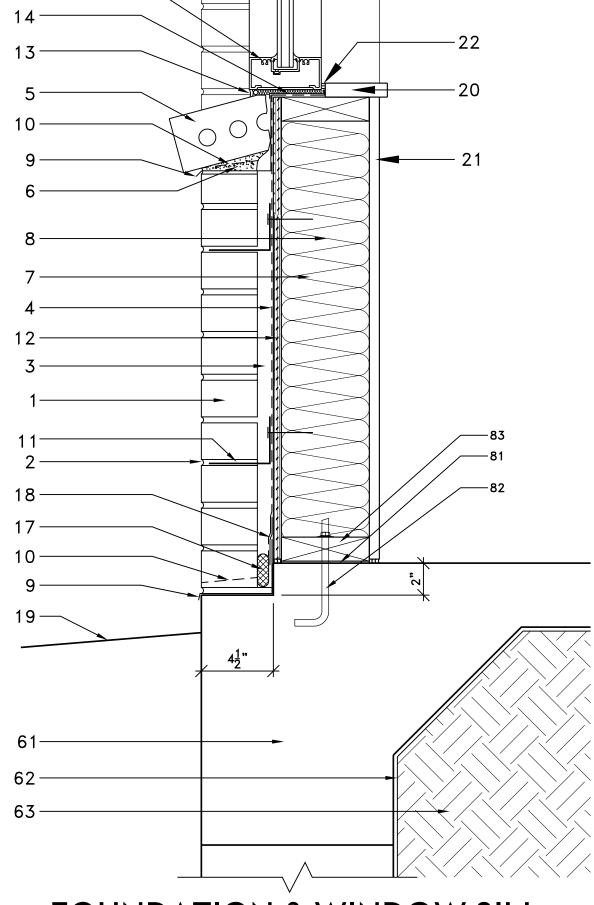
Dwg. Name

Building Sections

3. SECOND FLOOR SETBACK

2" = 1'-0"






1. FOUNDATION & WINDOW SILL

2. WINDOW HEADER 2" = 1'-0"

2" = 1'-0"


7. WINDOW HEADER AT STONE VENEER WALL

2" = 1'-0"

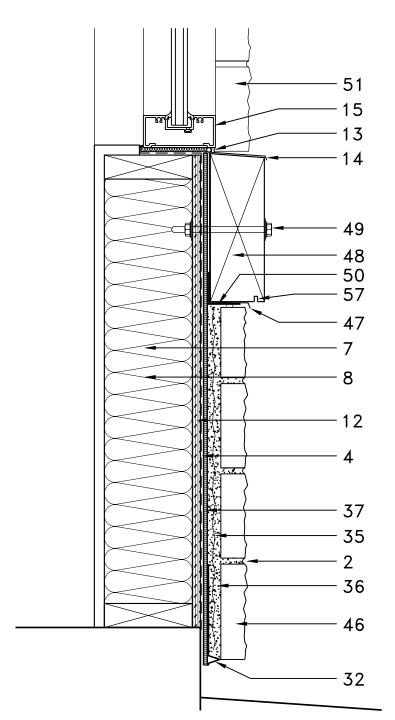


6. FOUNDATION & WINDOW SILL AT STONE VENEER WALL

2" = 1'-0"

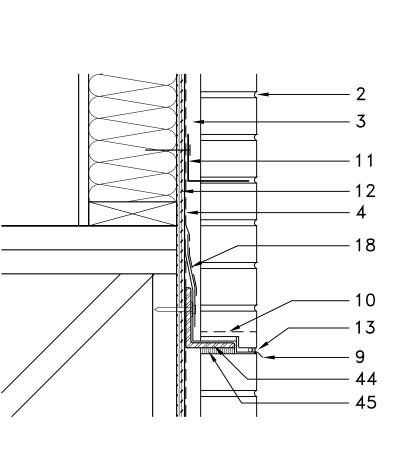

5. BRICK EXPANSION JOINT AT FLOOR TRANSITION

2" = 1'-0"

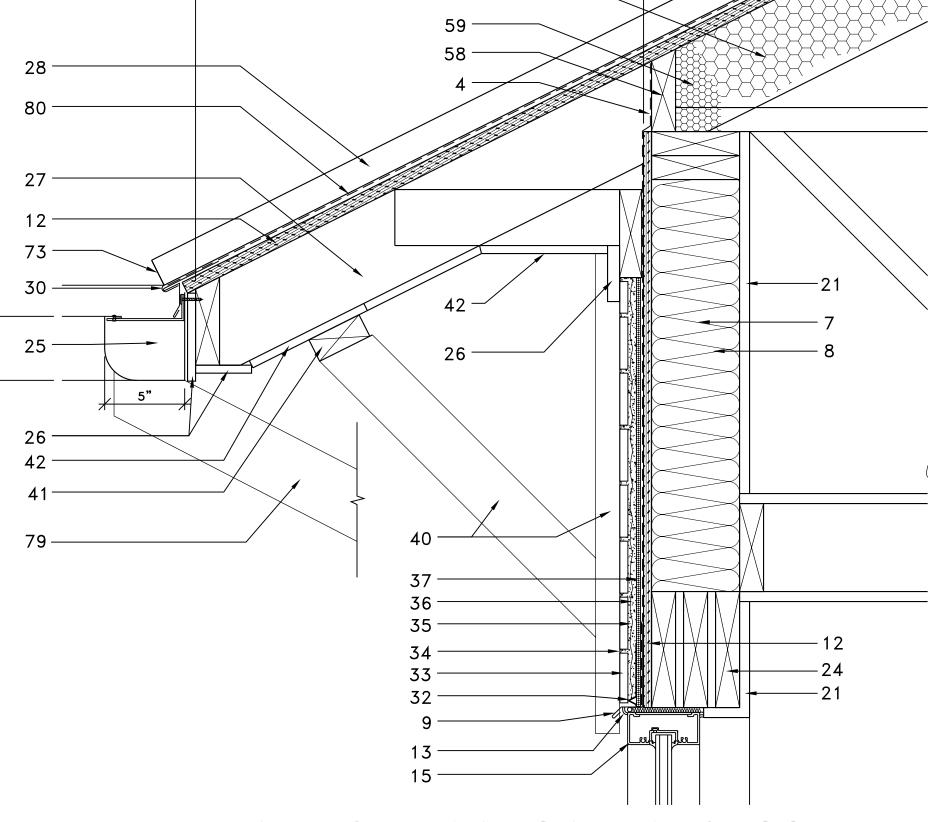

4. THIN BRICK @ WINDOW HEAD & ROOF

2" = 1'-0"

### **DETAILS KEYED NOTES:**

- SPECIFIED BRICK MASONRY. TOOLED MORTAR JOINT.
- 1" AIR SPACE.
- SPECIFIED MOISTURE BARRIER SLOPED BRICK SILL 15°.
- MORTAR BED.
- 2X6 STUD. REFER TO STRUCTURAL DWGS.
- 8. R-19 BATT INSULATION. THRU WALL FLASHING.
- 10. WEEP HOLES AT 24" O.C. 11. SPECIFIED BRICK ANCHORING SYSTEM.
- 12. ½" PLYWOOD SHEATHING PER STRUCTURAL DWGS. USE TREATED PLYWOOD AT FIRST ROW ABOVE
- 13. SEALANT & BACKER ROD. SEALANT TBD.
- 14. SILL FLASHING. 15. WINDOW ASSEMBLY.
- 16. BRICK BEYOND. 17. DRAINAGE PROTECTION SYSTEM.
- 18. FLEXIBLE MEMBRANE FLASHING.
- 19. FINISH GRADE. 20. PAINTED WOOD SILL.
- 21. %" GYP. BD. USE TYPE X GYP. BD. AT RATED
- 22. SEALANT. COORDINATE COLORS WITH ARCHITECT. 23. LINTEL ANGLE ATTACHED TO FRAMING.
- 24. HEADER BEAM PER STRUCTURAL DWGS. 25. CONT. GUTTER PART OF METAL ROOFING SYSTEM.
- 26. CEDAR CONT. FINISH TRIM. FINISH AS SPECIFIED. 27. RAFTERS. REFER TO STRUCTURAL DWGS.
- 28. SPECIFIED METAL SEAM ROOFING. PROVIDE ALL FLASHING AND CAULKING PER MANUFACTURER RECOMMENDATIONS.
- 29. FLOOR DECK PER STRUCT. DWGS. 30. METAL SEAM ROOF FLASHING SYSTEM PER MANUFACTURER SPECIFICATIONS. FLASHING COLOR
- TO MATCH ROOF COLOR. 31. STRUCTURAL TRUSS. REFER TO STRUCTURAL DWGS. 32. WEEP SCREED.
- 33. THIN BRICK VENEER TO MATCH MASONRY BRICK. 34. TOOLED MORTAR TO MATCH BRICK MASONRY.
- 35. GALVANIZED METAL LATH SCREWED TO SHEATHING OR TO CONCRETE SUBSTRATE.
- 36. MORTAR SETTING BED OVER ½" MORTAR SCRATCH
- 37. SPECIFIED DRAINAGE MAT OVER MOISTURE BARRIER. 38. BRICK SILL 3/4" OFF VENEER FACE.
- 39. 2 PIECE COUNTERFLASHING PER METAL SEAM ROOF SYSTEM DETAILS. FLASHING TO MATCH ROOF
- 40. WOOD BRACKETS BEYOND. REFER TO EXT. ELEVATIONS & 7/A5.1.
- 41. CONT. FINISH 2X4 TRIM. 42. CEDAR TONGUE & GROOVE SOFFIT. FINISH AS SPECIFIED.
- 43. R-28 MIN. BATT INSULATION AGAINST DECK BETWEEN TRUSS RAFTERS WITH WIRE SUPPORT. ALTERNATE: PNEUMATICALLY BLOWN INSULATION AGAINST DECK WITH PERMANENT SUPPORT SYSTEM. MIN. R−28.
- 44. LEDGER ANGLE.
- 45. COMPRESSIBLE FILLER.
- 46. SPECIFIED STONE VENEER. 47. METAL FLASHING FULL WIDTH BEHIND AND UNDER
- WOOD TRIM. 48. 4X10 CEDAR WOOD SILL. REFER TO ELEVATIONS FOR LENGTH. FINISH AS SPECIFIED.
- 49. GALVANIZED ½" BOLTS, WASHERS AND NUTS. APPLY SEALANT BETWEEN WASHERS AND WOOD. REFER TO
- EXTERIOR ELEVATIONS FOR BOLT LOCATIONS. 50. 14 GA GALVANIZED METAL ANGLE.
- 51. STONE VENEER BEYOND. 52. 2X4 CEDAR WOOD HEAD TRIM. FINISH AS
- SPECIFIED.

  53. METAL FLASHING. ALL FLASHING TO MATCH ADJACENT SURFACE COLOR.
- 54. SPECIFIED TONGUE AND GROOVE CEDAR SIDING.
- 55. 2X2 VERTICAL CEDAR TRIM. 56. VERTICAL ½" TREATED FURRING STRIPS AT 16" O.C.
- ALIGN WITH STUDS. AIR SPACE BETWEEN STRIPS.
- 58. CONT. WOOD BLOCKING TO SEAL ATTIC FROM
- OUTSIDE. 59. CLOSED CELL SPRAY FOAM INSULATION. INSTALL
- AT ALL WALL/ROOF CONNECTIONS TO SEAL ALL INFILTRATION POINTS. INSTALL AT SECOND FLOOR SETBACK DIRECTLY AGAINST ROOF SHEATHING TO SEAL ALL CONNECTIONS AND INSULATE ROOF TO A MIN. OF R28.
- 60. OPENING IN SHEATHING BETWEEN STUDS TO INSTALL INSULATION IN ROOF CAVITY. KEEP OPEN AND INSTALL INSULATION STOP SO INSULATION DOES NOT CLOSE OPENINGS. 61. SLAB AND FOUNDATION PER STRUCTURAL DWGS.
- 62. MOISTURE BARRIER. 63. SOIL PREPARED PER GEOTECH ENGINEER
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- SET ON TAPE SEALANT. SEALANT BEAD ALONG EDGE OF CLOSURE AND OVER TOP OF PANEL
- 71. BOX PANEL ENDS.
- 72. PANEL CLIP AND FASTENERS. 73. SEALANT TO CLOSE END OF PANELS.
- 74. ROOF PIPE PENETRATION. 4" DIA MAX. 75. RUBBER BOOT FLASHING. 76. SET BOOT INTO CONT. CAULK BEAD. USE FASTENERS PER BOOT MANUFACTURER
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- 78. REFER TO STRUCTURAL DWGS FOR SLAB AND FOUNDATION REINFORCING.
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- 81. CONT. CLOSED CELL FOAM SILL SEALER WITH SELF ADHESIVE WATERPROOFING MEMBRANE BETWEEN CONCRETE AND PLATE.
- 82. PLATE ANCHOR AT 48" O.C.. REFER TO STRUCTURAL DWGS.
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Shawn Kashou, Architect 20710 Shadow Mill Ct Katy, Texas 77450 Tel: 713 . 965 4470

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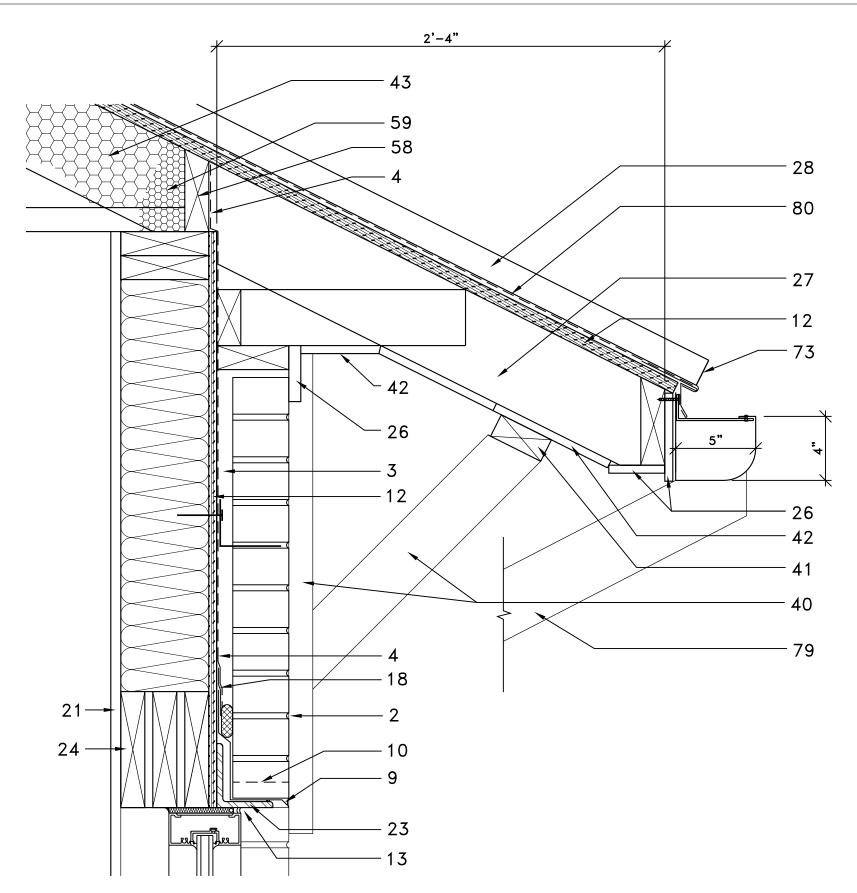
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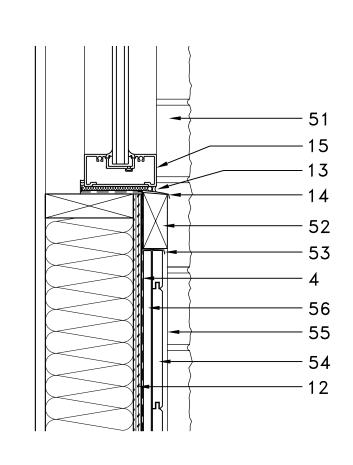
Dwg. Name **Details** 

# 4. VERTICAL BRICK EXPANSION JOINT

2" = 1'-0"



2. WINDOW HEAD AT STONE VENEER WALL 2" = 1'-0"




1. WINDOW SILL AT STONE VENEER WALL

2" = 1'-0"

3. BRICK MASONRY @ WINDOW HEAD & ROOF


2" = 1'-0"

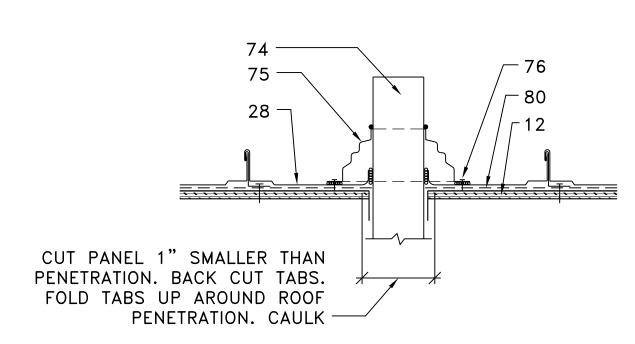


LOCATE PIPE PENETRATION IN PAN OF PANEL ONLY.

### 8. ROOF PENETRATIONS


2" = 1'-0"

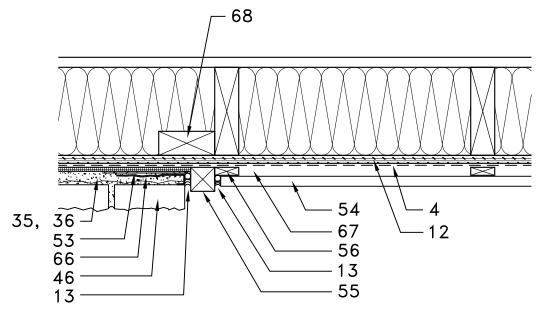

7. STONE / SIDING TRANSITION 2" = 1'-0"

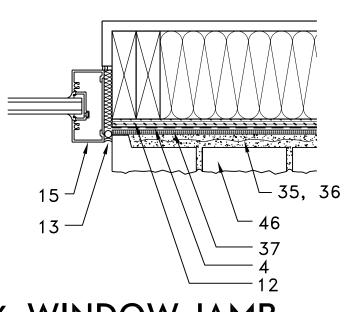


6. WINDOW JAMB 2" = 1'-0"

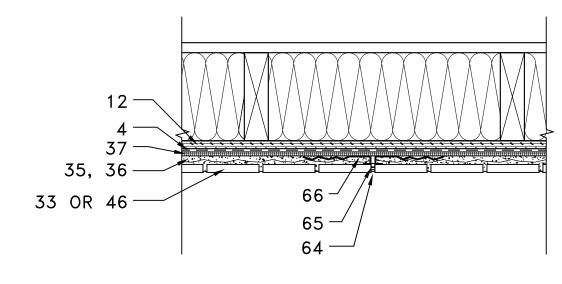


5. THIN BRICK/STONE **EXPANSION JOINT** 

2" = 1'-0"

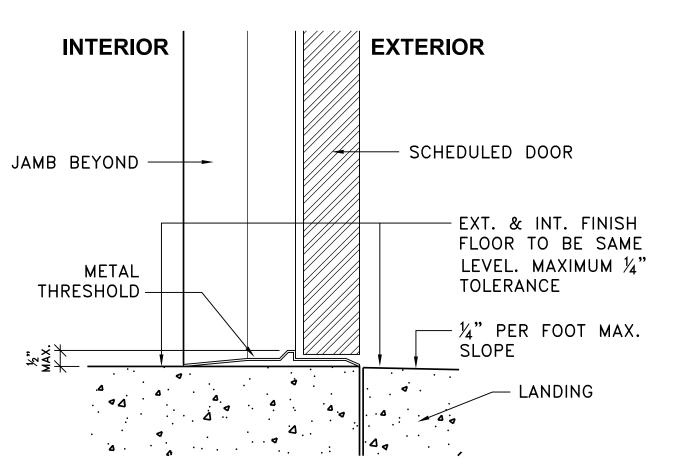

10. DOOR LANDING

NTS

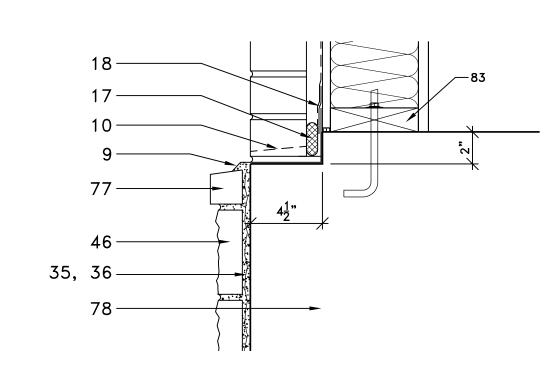

9. BRICK / STONE TRANSITION

2" = 1'-0"

### **DETAILS KEYED NOTES:**

- SPECIFIED BRICK MASONRY. TOOLED MORTAR JOINT.
- 1" AIR SPACE.
- SPECIFIED MOISTURE BARRIER SLOPED BRICK SILL 15°.
- MORTAR BED.
- 2X6 STUD. REFER TO STRUCTURAL DWGS. 8. R-19 BATT INSULATION.
- THRU WALL FLASHING. 10. WEEP HOLES AT 24" O.C.
- 11. SPECIFIED BRICK ANCHORING SYSTEM. 12. ½" PLYWOOD SHEATHING PER STRUCTURAL DWGS.

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Shawn Kashou, Architect

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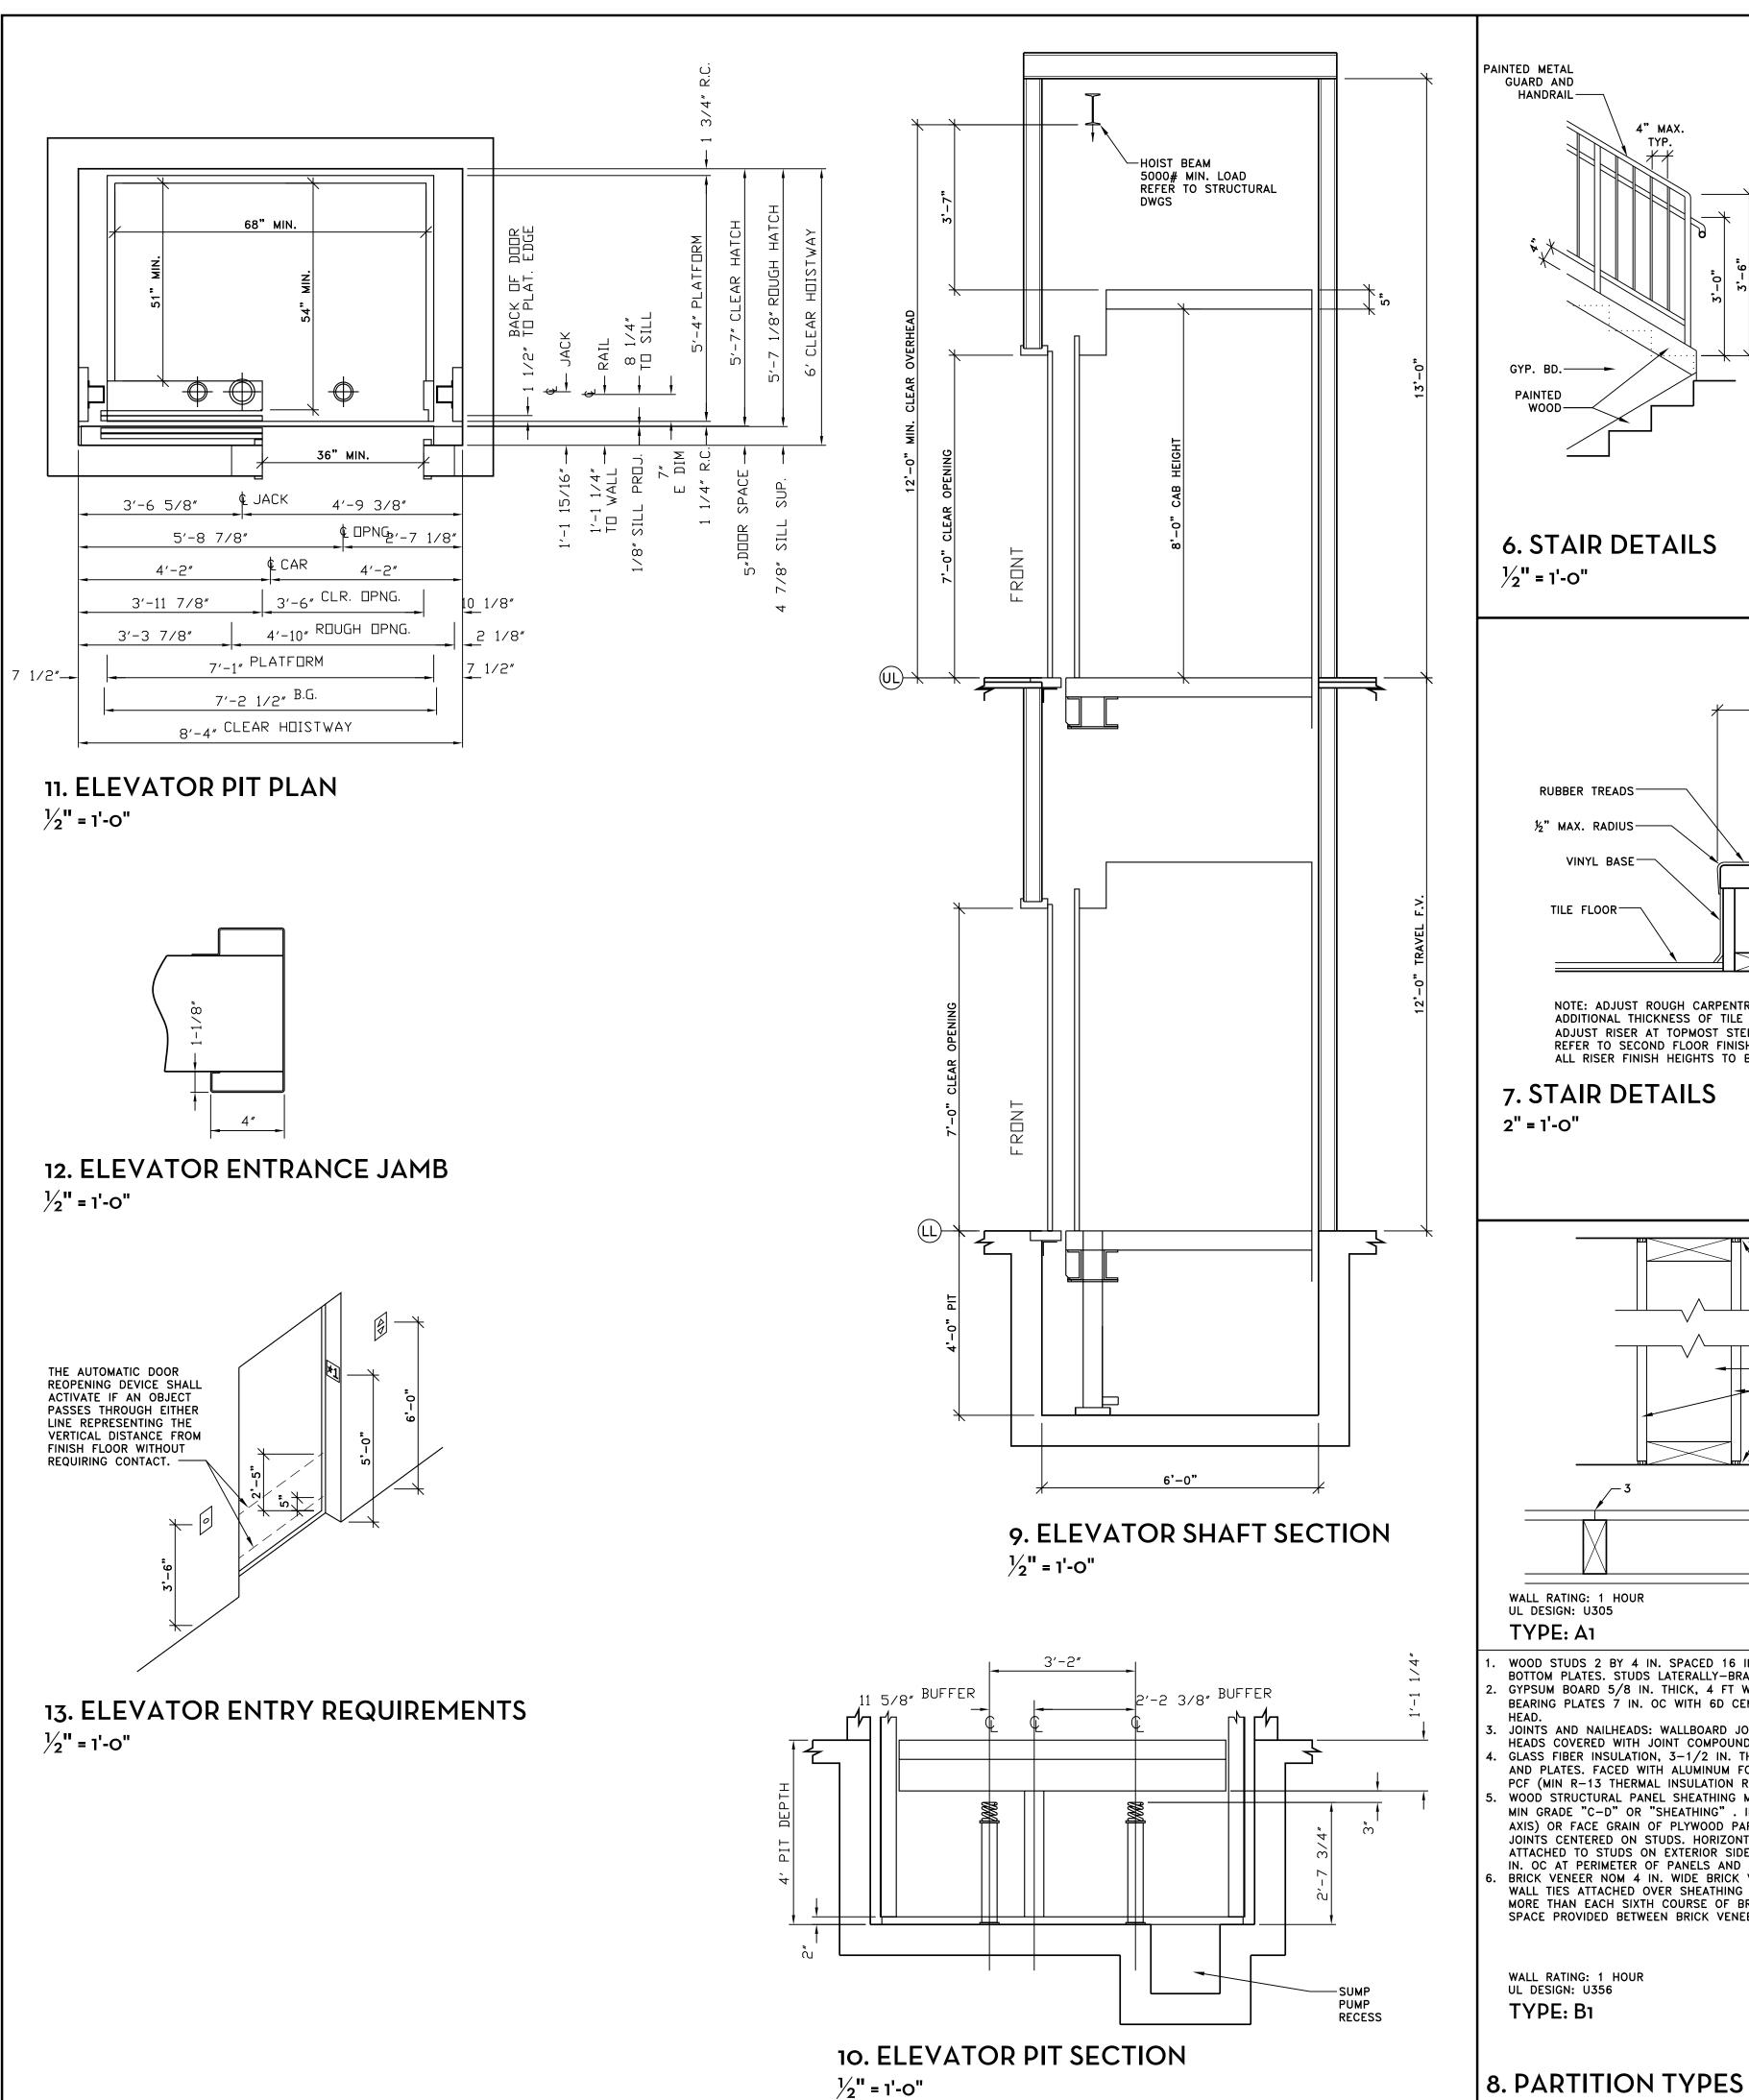
- USE TREATED PLYWOOD AT FIRST ROW ABOVE FOUNDATION.
  13. SEALANT & BACKER ROD. SEALANT TBD.
- 14. SILL FLASHING.
- 15. WINDOW ASSEMBLY.
- 16. BRICK BEYOND. 17. DRAINAGE PROTECTION SYSTEM.
- 18. FLEXIBLE MEMBRANE FLASHING.
- 19. FINISH GRADE.
- 20. PAINTED WOOD SILL. 21. %" GYP. BD. USE TYPE X GYP. BD. AT RATED
- 22. SEALANT. COORDINATE COLORS WITH ARCHITECT.
- 23. LINTEL ANGLE ATTACHED TO FRAMING.
- 24. HEADER BEAM PER STRUCTURAL DWGS. 25. CONT. GUTTER PART OF METAL ROOFING SYSTEM.
- 26. CEDAR CONT. FINISH TRIM. FINISH AS SPECIFIED. 27. RAFTERS. REFER TO STRUCTURAL DWGS. 28. SPECIFIED METAL SEAM ROOFING. PROVIDE ALL
- FLASHING AND CAULKING PER MANUFACTURER RECOMMENDATIONS.
- 29. FLOOR DECK PER STRUCT. DWGS. 30. METAL SEAM ROOF FLASHING SYSTEM PER MANUFACTURER SPECIFICATIONS. FLASHING COLOR TO MATCH ROOF COLOR.
- 31. STRUCTURAL TRUSS. REFER TO STRUCTURAL DWGS. 32. WEEP SCREED.
- 33. THIN BRICK VENEER TO MATCH MASONRY BRICK. 34. TOOLED MORTAR TO MATCH BRICK MASONRY.
- 35. GALVANIZED METAL LATH SCREWED TO SHEATHING OR TO CONCRETE SUBSTRATE. 36. MORTAR SETTING BED OVER ½" MORTAR SCRATCH
- 37. SPECIFIED DRAINAGE MAT OVER MOISTURE BARRIER.
- 38. BRICK SILL 3/4" OFF VENEER FACE. 39. 2 PIECE COUNTERFLASHING PER METAL SEAM ROOF


SYSTEM DETAILS. FLASHING TO MATCH ROOF


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- 43. R-28 MIN. BATT INSULATION AGAINST DECK BETWEEN TRUSS RAFTERS WITH WIRE SUPPORT. ALTERNATE: PNEUMATICALLY BLOWN INSULATION AGAINST DECK WITH PERMANENT SUPPORT SYSTEM. MIN. R−28.
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- EDGE OF CLOSURE AND OVER TOP OF PANEL
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- 74. ROOF PIPE PENETRATION. 4" DIA MAX. 75. RUBBER BOOT FLASHING. 76. SET BOOT INTO CONT. CAULK BEAD. USE FASTENERS PER BOOT MANUFACTURER
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- CONCRETE AND PLATE. 82. PLATE ANCHOR AT 48" O.C.. REFER TO
- STRUCTURAL DWGS. 83. TREATED SILL PLATE. TYP. ALL FIRST FLOOR

Dwg. Name Details

Project No.



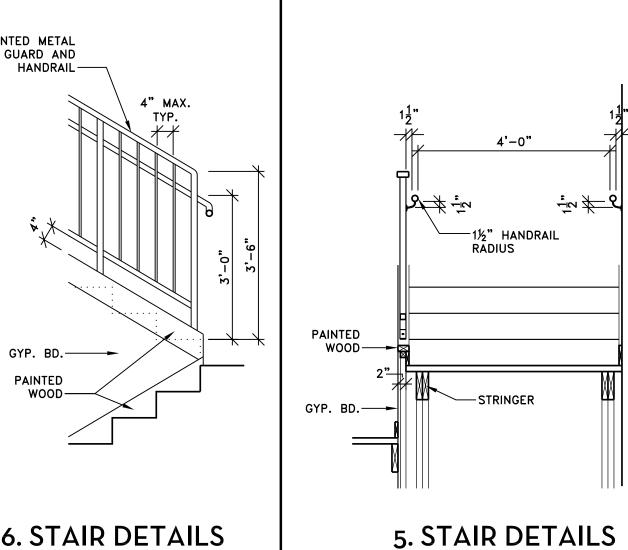

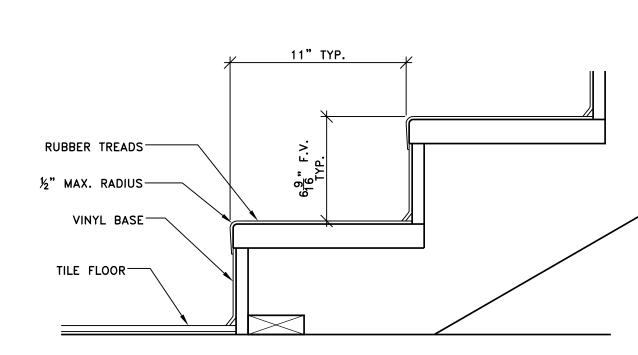


<sup>1</sup>/<sub>2</sub>" = 1'-0"

NOTE: ADJUST ROUGH CARPENTRY HEIGHT OF FIRST STEP TO ACCOUNT FOR THE ADDITIONAL THICKNESS OF TILE FLOORING AT THE FIRST FLOOR LANDING. ADJUST RISER AT TOPMOST STEP TO ACCOUNT FOR ADDITIONAL 1/4" AT TOP LANDING. REFER TO SECOND FLOOR FINISH PLAN. ALL RISER FINISH HEIGHTS TO BE EQUAL.

# 7. STAIR DETAILS

2"= 1'-0"

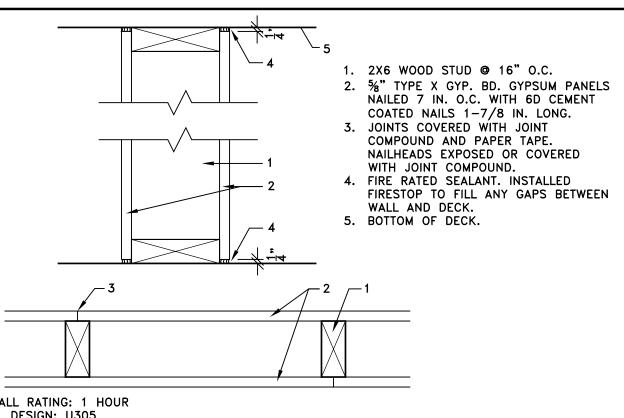


- WOOD STUDS 2 BY 4 IN. SPACED 16 IN. OC WITH TWO 2 BY 4 IN. TOP AND ONE 2 BY 4 IN. BOTTOM PLATES. STUDS LATERALLY-BRACED BY WOOD STRUCTURAL PANEL SHEATHING.


  GYPSUM BOARD 5/8 IN. THICK, 4 FT WIDE, APPLIED VERTICALLY AND NAILED TO STUDS AND BEARING PLATES 7 IN. OC WITH 6D CEMENT-COATED NAILS, 1-7/8 IN. LONG WITH 1/4 IN. DIAM
- JOINTS AND NAILHEADS: WALLBOARD JOINTS COVERED WITH TAPE AND JOINT COMPOUND. NAIL HEADS COVERED WITH JOINT COMPOUND.


  GLASS FIBER INSULATION, 3-1/2 IN. THICK, PRESSURE FIT TO FILL WALL CAVITIES BETWEEN STUDS AND PLATES. FACED WITH ALUMINUM FOIL OR KRAFT PAPER AND TO HAVE A MIN DENSITY OF 0.9
- PCF (MIN R-13 THERMAL INSULATION RATING).


  WOOD STRUCTURAL PANEL SHEATHING MIN 7/16 IN. THICK, 4 FT WIDE WOOD STRUCTURAL PANELS,
  MIN GRADE "C-D" OR "SHEATHING". INSTALLED WITH LONG DIMENSION OF SHEET (STRENGTH AXIS) OR FACE GRAIN OF PLYWOOD PARALLEL WITH OR PERPENDICULAR TO STUDS. VERTICAL JOINTS CENTERED ON STUDS. HORIZONTAL JOINTS BACKED WITH NOM 2 BY 4 IN. WOOD BLOCKING. ATTACHED TO STUDS ON EXTERIOR SIDE OF WALL WITH 6D CEMENT COATED BOX NAILS SPACED 6
  IN. OC AT PERIMETER OF PANELS AND 12 IN. OC ALONG INTERIOR STUDS.


  BRICK VENEER NOM 4 IN. WIDE BRICK VENEER. BRICK VENEER FASTENED WITH CORRUGATED METAL
- WALL TIES ATTACHED OVER SHEATHING TO WOOD STUDS WITH 8D NAIL PER TIE: TIES SPACED NOT MORE THAN EACH SIXTH COURSE OF BRICK AND MAX 32 IN. OC HORIZONTALLY. ONE IN. AIR SPACE PROVIDED BETWEEN BRICK VENEER AND SHEATHING.

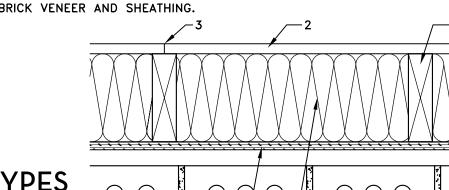


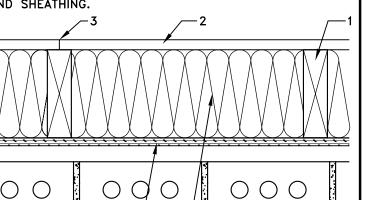

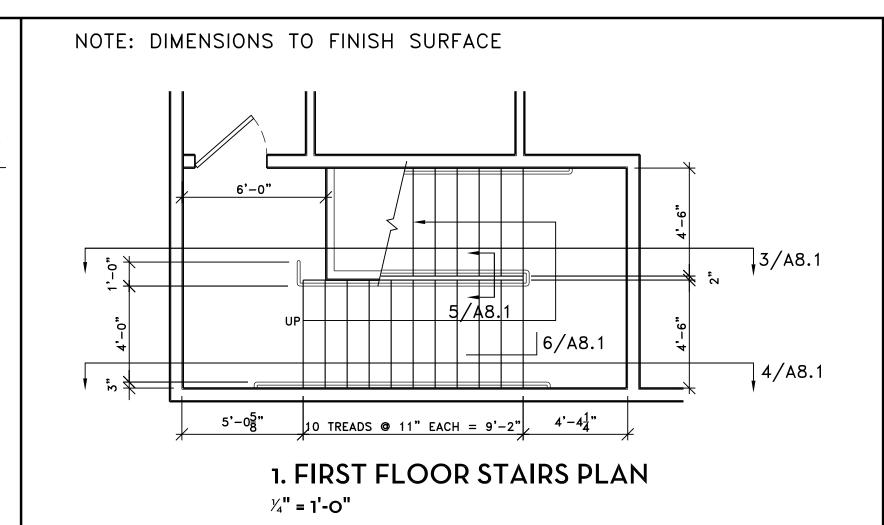

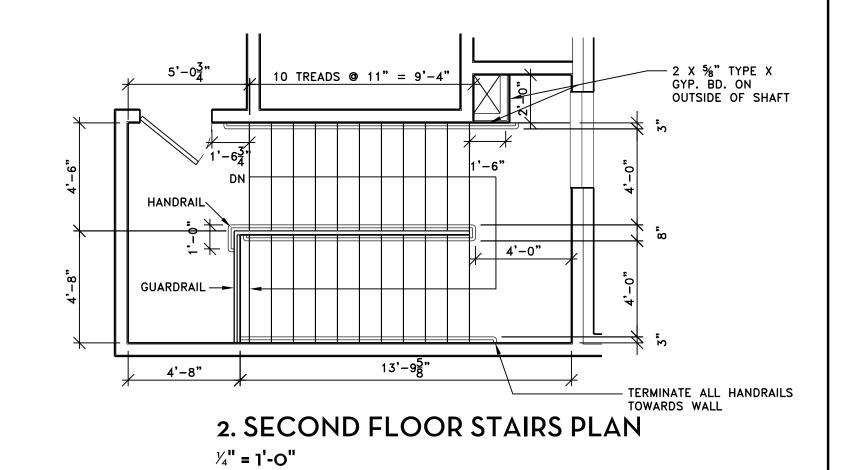

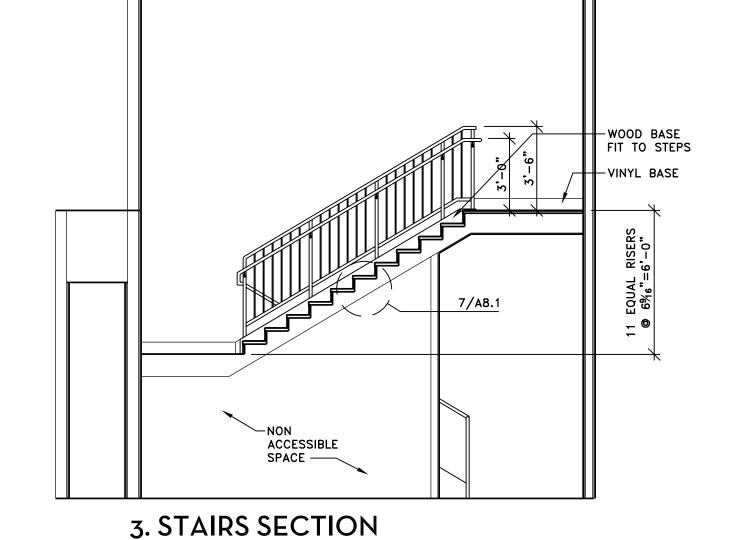

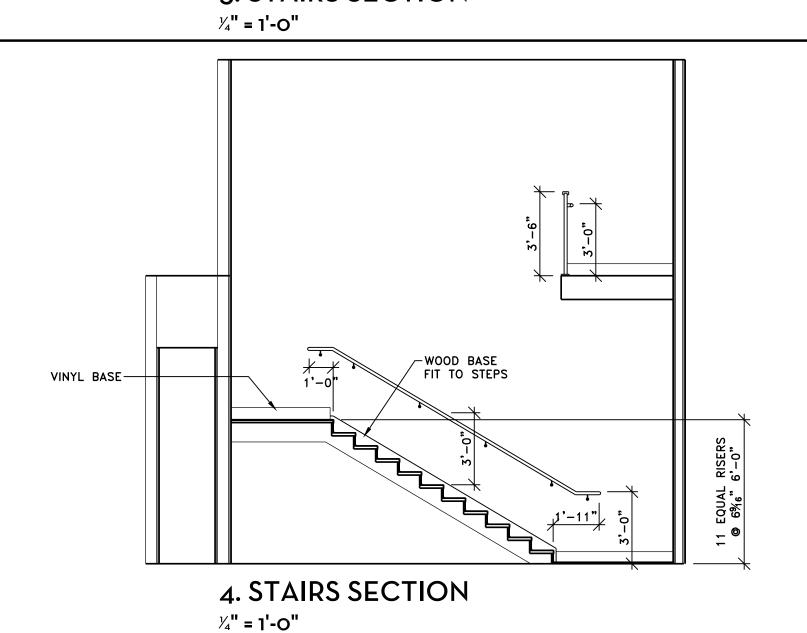


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Kashou Shawn Kashou, Architect

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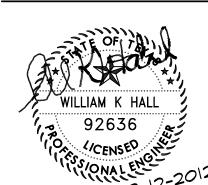


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**Enlarged Plans** 

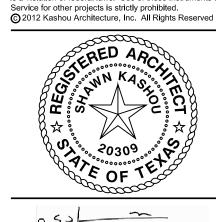

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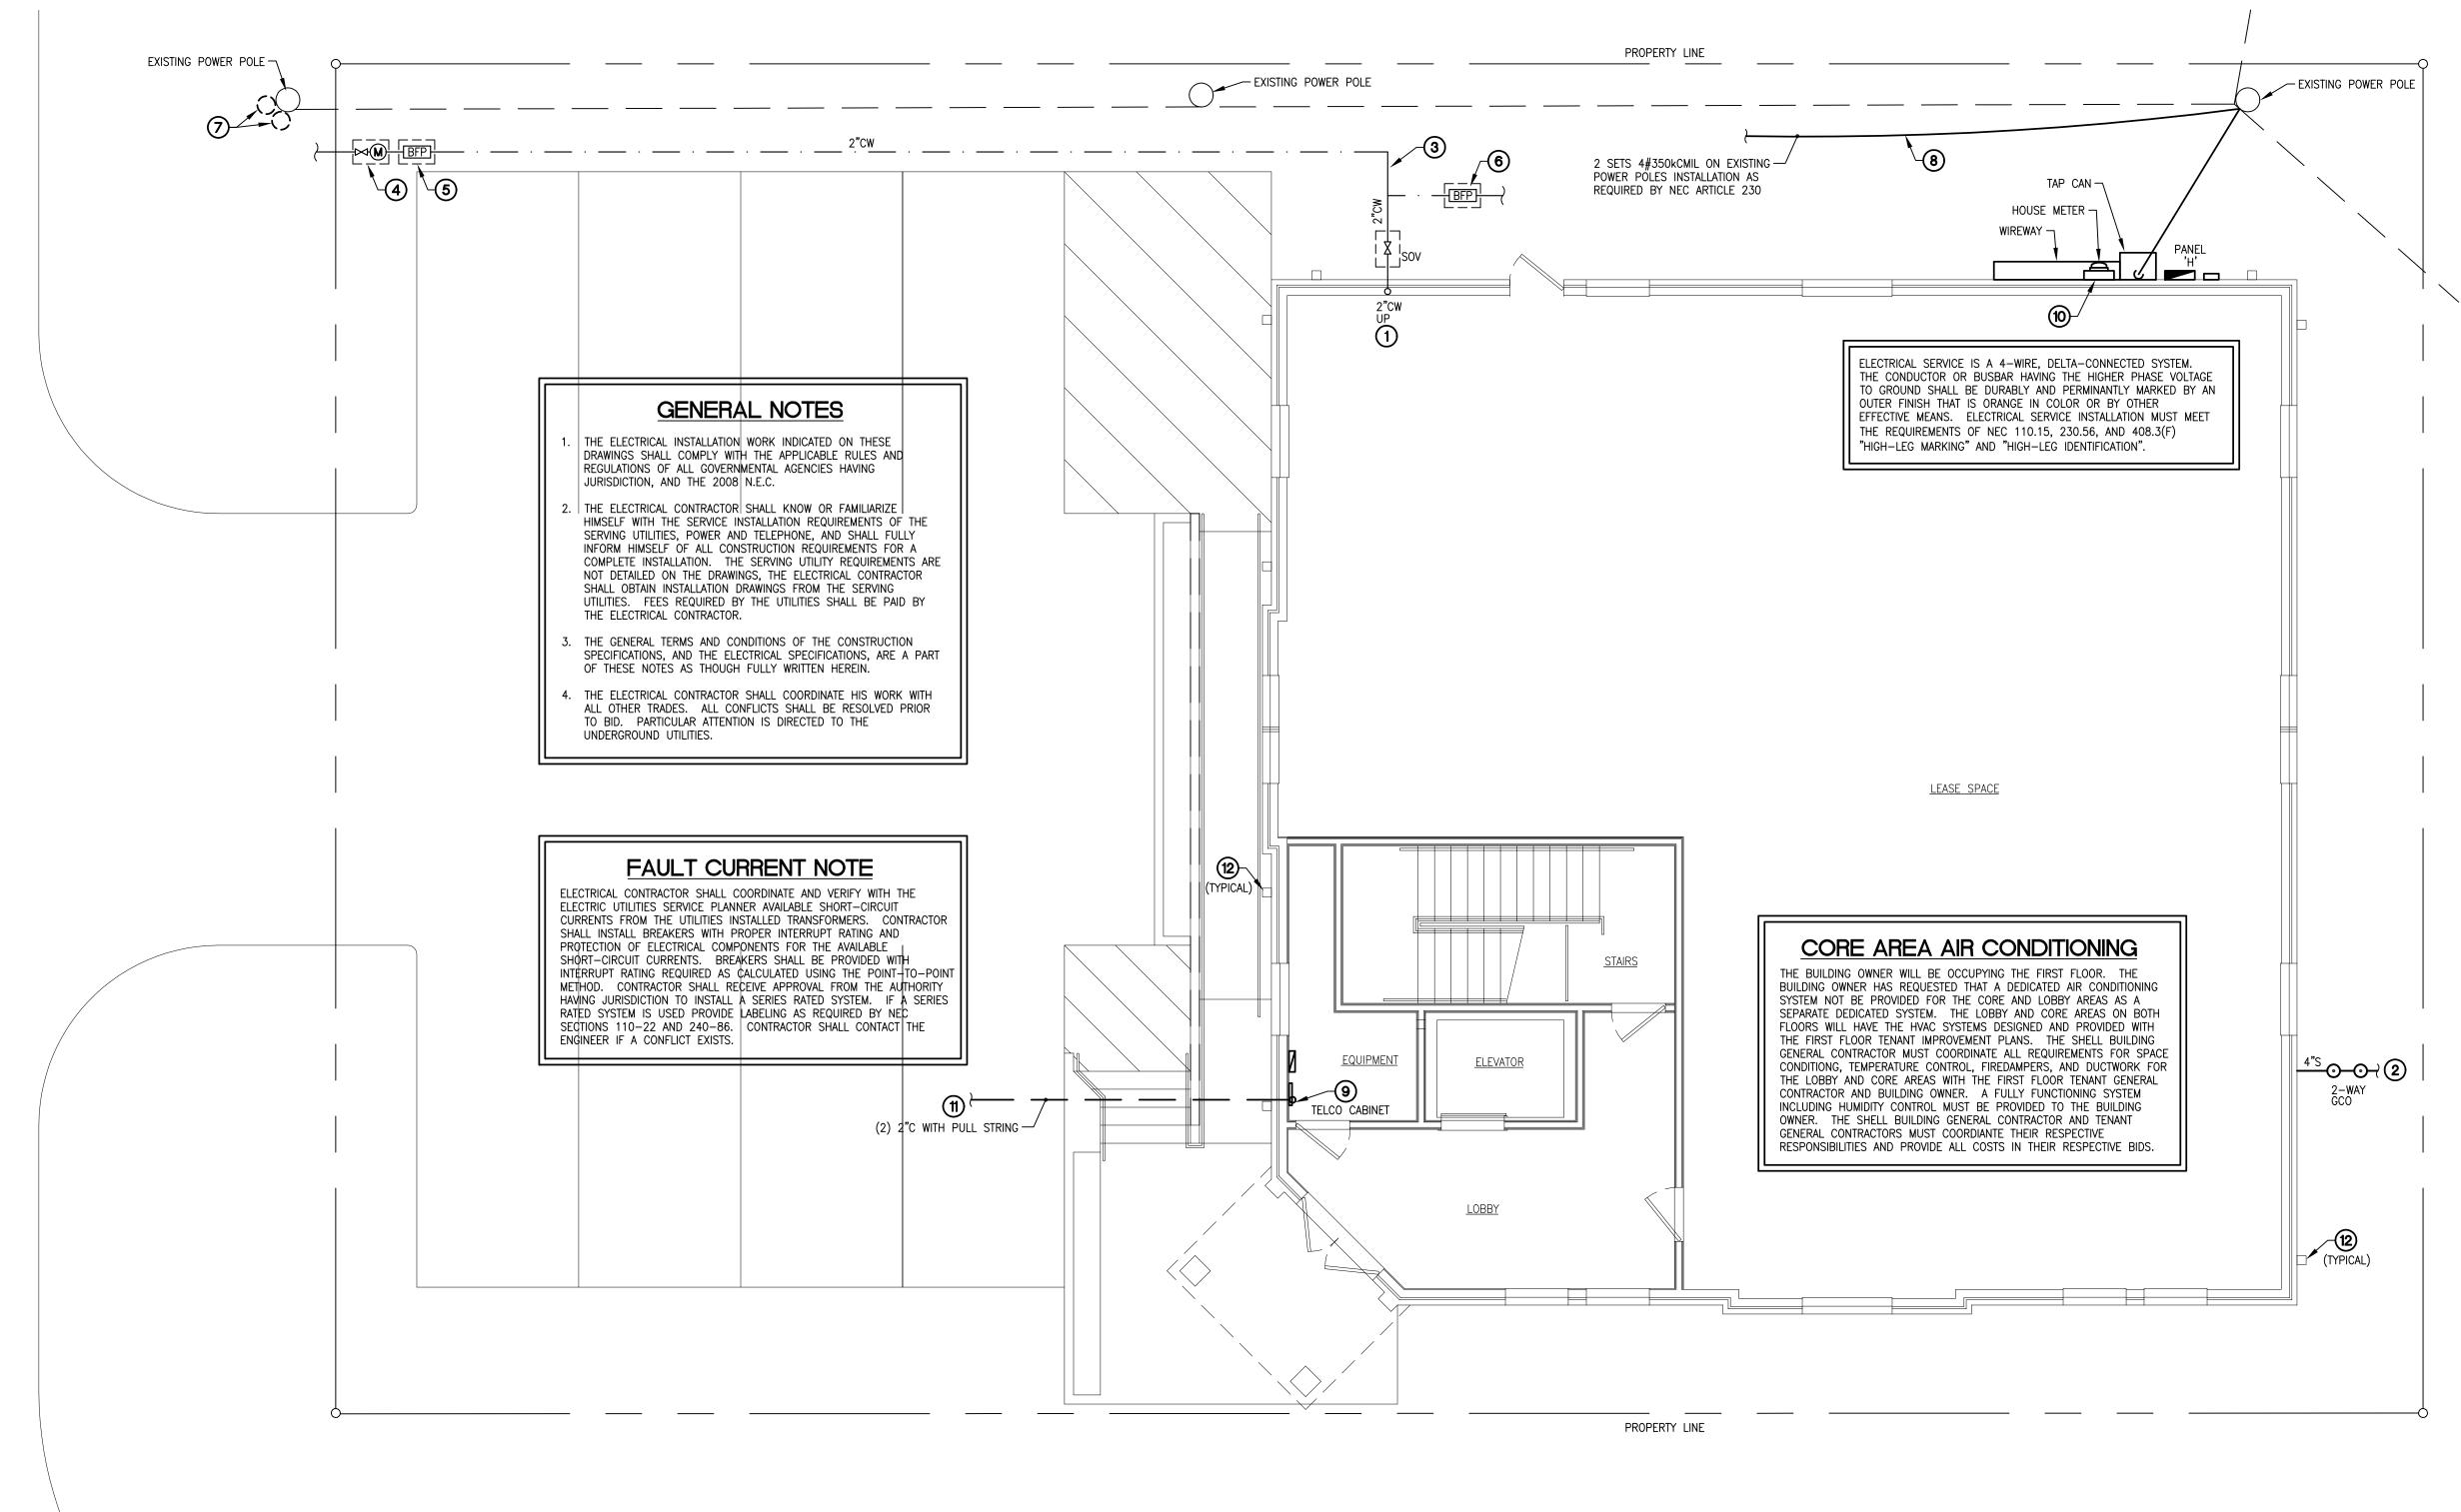
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Dwg. Name

PLUMBING AND ELECTRICAL SITE **PLAN** 

Dwg. No.








REQUIREMENTS.

REQUIREMENTS.

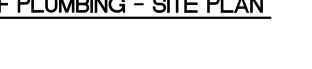

EXTEND (2) 2" SCH. 40 PVC CONDUITS WITH PULL STRINGS, 36" BELOW GRADE FROM

REFER TO CIVIL PLANS FOR STORM DRAINAGE CONDUCTOR AND DRAINAGE PIPING

REFER TO CIVIL PLANS FOR STORM DRAINAGE CONDUCTOR AND DRAINAGE PIPING

UTILITY PRIOR TO CONSTRUCTION OR COMMENCEMENT OF WORK.

NEW COMMUNICATIONS/TELEPHONE BOARD OR DEMARK CABINET TO LOCATION ON SITE

DESIGNATED BY TELEPHONE COMPANY. COORDINATE CONDUIT TERMINATION POINTS WITH



### SITE PLAN KEYED NOTES:

- 2" DOMESTIC WATER SERVICE. COORDINATE PIPE ROUTING, WATER METER LOCATION, SHUTOFF VALVE, AND BACKFLOW LOCATION WITH CIVIL. PROVIDE AS REQUIRED BY UTILITY AND LOCAL AUTHORITY HAVING JUTISDICTION (AHJ).
- 4" BUILDING SANITARY SEWER. REFER TO CIVIL FOR CONTINUATION. SANITARY SEWER LINE 4" AND GREATER SHALL BE SLOPED AT 1/4" PER FOOT, 1/8" PER FOOT MINIMUM ONLY IF APPROVED BY THE LOCAL AUTHORITY HAVING JURISDICTION.
- (3) WATER SERVICE PIPING BELOW GRADE SHALL HAVE SEPARATION FROM BUILDING SEWER LINES AS REQUIRED BY SECTION #603 OF THE INTERNATIONAL PLUMBING CODE.
- (4) WATER METER FOR DOMESTIC WATER SERVICE IN YARD BOX OR AS REQUIRED BY UTILITY. COORDINATE METER AND TAP LOCATION WITH UTILITY AND CIVIL. INSTALLATION SHALL BE AS REQUIRED BY LOCAL UTILITY COMPANY. CONTRACTOR SHALL PROVIDE AND INSTALL METERS REQUIRED BY AUTHORITY HAVING JURISDICTION. REFER TO CIVIL.
- BUILDING DOMESTIC WATER SUPPLY BACKFLOW PREVENTER IN YARD BOX OR AS REQUIRED BY UTILITY. COORDINATE BACKFLOW PREVENTION LOCATION WITH CIVIL.
- BACKFLOW PREVENTER FOR SPRINKLER SYSTEM AND LANDSCAPE WATERING. PROVIDE METERING WHERE REQUIRED BY OWNER OR AHJ. COORDINATE LOCATION WITH LANDSCAPE CONTRACTOR AND CIVIL. INSTALL BACKFLOW AS REQUIRED BY LOCAL UTILITY AND AHJ. REFER TO LANDSCAPE PLANS FOR SPRINKLER SYSTEM REQUIREMENTS.

- POWER COMPANY POLE MOUNTED TRANSFORMERS. COORDINATE TRANSFORMER LOCATION, ARRANGEMENT, VOLTAGE AND REQUIREMENTS WITH POWER COMPANY PRIOR TO COMMENCEMENT OF WORK.
- TRANSFORMERS TO TAP CAN. ELECTRICAL CONTRACTOR SHALL PROVIDE AND INSTALL ALL SERVICE ENTRANCE EQUIPMENT AND POLE MOUNTED CONDUCTORS AS REQUIRED BY LOCAL ELECTRICAL UTILITY, LOCAL AUTHORITY HAVING JURISDICTION AND NATIONAL ELECTRICAL CODE ARTICLE 230. REFER TO ELECTRICAL RISER DIAGRAM FOR ADDITIONAL INFORMATION AND REQUIREMENTS.
- TELEPHONE BOARD OR DEMARK CABINET. PROVIDE TWO (2) 2" CONDUITS WITH PULL STRINGS TO TELEPHONE PEDISTAL OR PROPERTY LINE LOCATION AS DIRECTED BY COMMUNICATIONS UTILITY COMPANIES. CONTRACTOR SHALL INSTALL PHONE SYSTEM AS DIRECTED BY OWNER. INSTALLATION SHALL PROVIDE FOR SERVICE FOR ALL LOW VOLTAGE TELE/DATA SERVICES INCLUDING TELEPHONE, CABLE, DATA, SECURITY, FIRE ALARM AND ANY OTHER SYSTEMS AS REQUIRED BY OWNER. INSTALLATION SHALL BE AS REQUIRED BY THE UTILITY COMPANY. PROVIDE ADDITIONAL CONDUITS WITH PULL STRINGS AND POINTS
- METER AND DISCONNECT. VERIFY LOCATION WITH LANDLORD AND UTILITY. INSTALL AS REQUIRED BY LOCAL UTILITY AND AHJ. IF A CONFLICT EXISTS NOTIFY ARCHITECT IMMEDIATELY.

- 8 ROUTE SERVICE ENTRANCE CONDUCTORS FROM UTILITIY COMPANIES POLE MOUNTED CONTACT CENTERPOINT SERVICE PLANNER: CURTIS NEWBERRY - (281) 391-5150
- OF CONNECTION WHERE REQUIRED.

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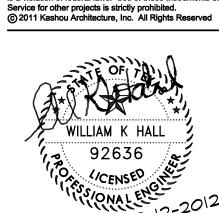
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Texas Firm Registration: #F-12258

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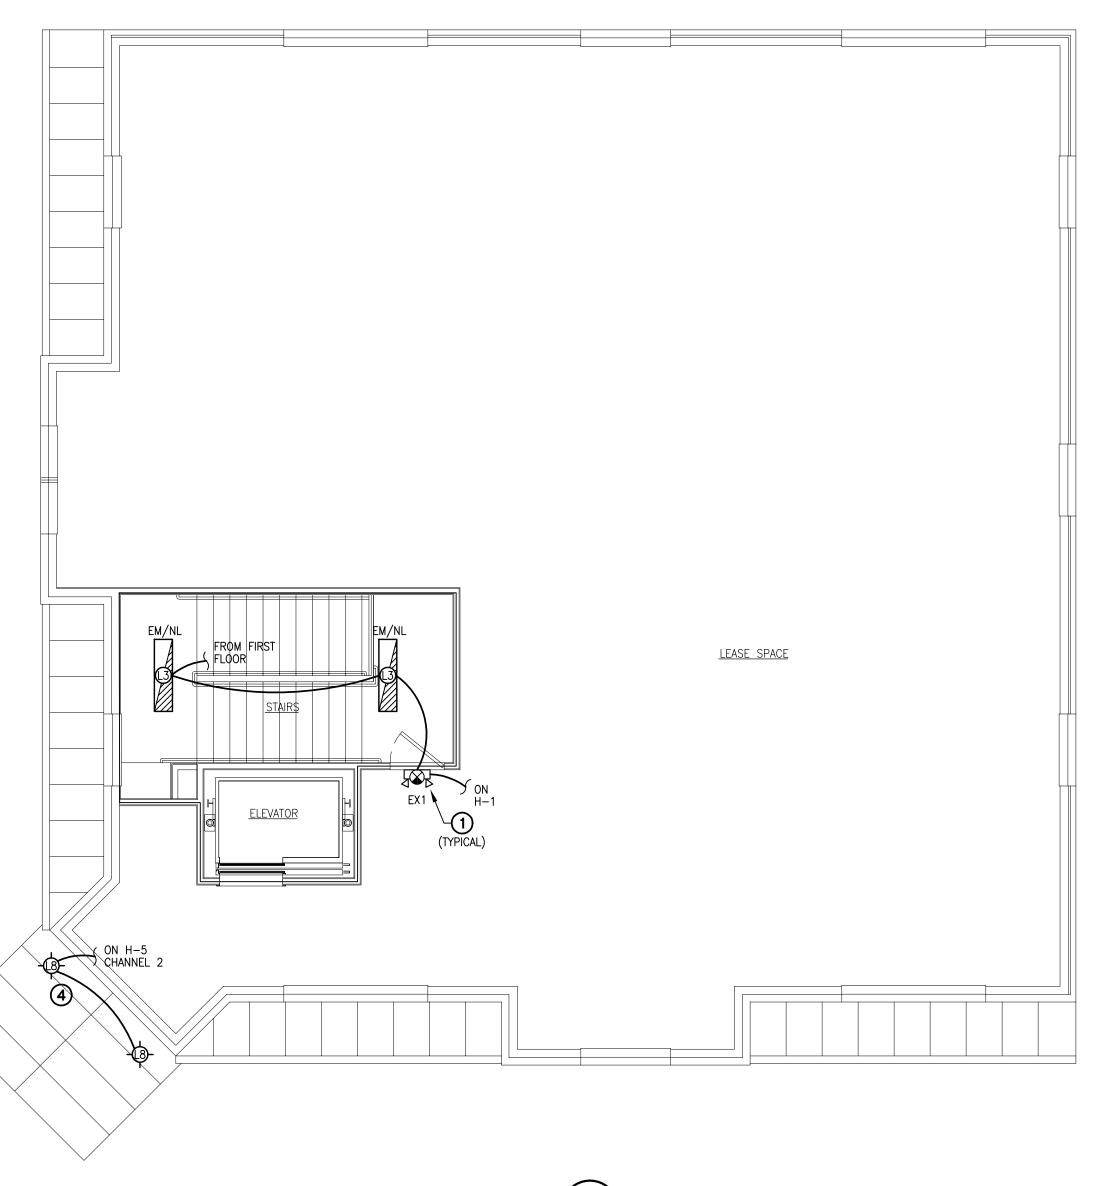
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Dwg. Name

ELECTRICAL LIGHTING PLANS

Dwg. No.


E-2



2 LIGHTING PLAN - SECOND FLOOR

3/16" = 1'-0"

NOTE:
POWER TO LIGHTING CIRCUITS SHALL BE CONTROLLED BY THE LIGHTING TIME CLOCK.
REFER TO ELECTRICAL RISER DIAGRAM ON SHEET E3.0. COORDINATE CIRCUITS
CONTROLLED WITH OWNER PRIOR TO CONSTRUCTION.

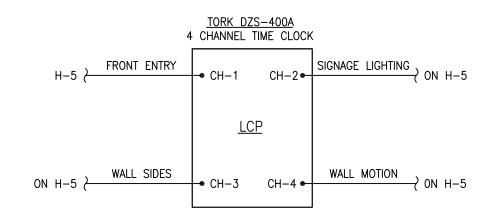

CONTACTORS WHEN REQUIRED SHALL BE SQUARE D TYPE 'L' (OR EQUAL) NORMALLY OPEN, ELECTRICALLY HELD, 120-VOLT. REFER TO DIAGRAM FOR NUMBER OF POLES REQUIRED.

LCP (LIGHTING CONROL PANEL) TO ACTIVATE CONTACTORS AT TIMES DESIGNATED BY OWNER OR LANDLORD.

3 HOUSE LIGHTING CONTROL DIAGRAM
NOT TO SCALE

### LIGHTING FIXTURE SCHEDULE WATTS/FIX VOLTS TYPE SYMBOL DESCRIPTION/MANUFACTURER MOUNTING LAMPS HALO #H272ICAT, 6" COMPACT FLUORESCENT DOWNLIGHT, ELECTRONIC BALLAST, 26W TTT RECESSED 120V 28W WHITE TRIM AND METALLIC REFLECTOR. METALUX #WSA2-28T5-A120, 48" LINEAR FLUORESCENT, ELECTRONIC BALLAST, SURFACE (2) 28W T5 120V 2-TUBE T5, WRAPAROUND ACRYLIC LENS. METALUX #WSA2-28T5-A120-EL, 48" LINEAR FLUORESCENT, ELECTRONIC BALLAST, 2-TUBE T5, WRAPAROUND ACRYLIC LENS, (-EL) EMERGENCY LIGHT KIT INCLUDING ' (2) 28W T5 SURFACE 68W 120V 90 MINUTE EMERGENCY BALLAST. SHAPER #666-WP-16-CFL127-120-NBZ-DL-VRD, 16" LANTERN FIXTURE, SURFACE 27W TT 120V 29W 27W-2G11 CFL, 120 VOLT, DAMP LOCATIONS, VANDAL RESISTANT ACRYLIC DIFFUSER. SHAPER #660-WP-CFL132-120-NBZ, WEATHER PROOF, FLOATING SHIELD SCONCE, L5 SURFACE 32W TTT 35W 120V 32W, TRIPPLE CFL, 120 VOLT, NATURAL BRONZE. LUMARK #XTOR3A-N-PC1, CROSSTOUR LED WALLPACK, 30W, 3500K KELVIN, WET SURFACE 30W LED 30W 120V LOCATION, CARBON BRONZE, 120V. ACCESS FIXTURES #WPC15F32EL, CONSTELLATION MEDIUM FULL CUTOFF WALL PACK, SURFACE 32W TTT 34W 120V COMPACT FLUORESCENT, ELECTRONIC BALLAST. PROVIDE WITH MOTION DETEDTOR. LUMIERE CARMEL #403-50T4-12V-BZ, VERIFY FINISH, ARM LENGTH AND ARM SURFACE Q50T4/CL L8 50W 12V OPTIONS WITH OWNER. PROVIDE AND INSTALL TRANSFORMER AS REQOMMENDED BY SURE LITES #CU2, EMERGENCY LIGHT, EMERGENCY BATTERY PACK, MINIMUM 90 EL1 SURFACE 120 WITH FIXTURE MINUTES OF BATTERY POWER AND TEST SWITCH. SURE LITES #AP, COMBINATION EXIT/EMERGENCY LIGHT, EMERGENCY BATTERY PACK, EX1 SURFACE WITH FIXTURE 120 \_\_\_ SQUARE HEADS, MINIMUM 90 MINUTES OF BATTERY POWER AND TEST SWITCH. SURE LITES #ES7-1-70-S-BZ-R-W, EXIT LIGHT, EMERGENCY BATTERY PACK, EX2 SURFACE 120 WITH FIXTURE MINIMUM 90 MINUTES OF BATTERY POWER AND TEST SWITCH.

**6** [L7]

**ELEVATOR** 

### NOTES:

EXIT LIGHTS TO BE PROVIDED WITH UNIVERSAL MOUNTING HARDWARE FOR CEILING OR WALL MOUNTING.
 CONTRACTOR SHALL SUBMIT CUT SHEETS FOR ALL LIGHTING FIXTURES TO ARCHITECT AND OWNER FOR APPROVAL PRIOR TO ORDERING OF FIXTURES. OWNER WILL MAKE FINAL DECISION ON ALL FIXTURES.

# 1 LIGHTING PLAN - FIRST FLOOR 3/16" = 1'-0"

ON H-5 CHANNEL 4


LEASE SPACE

ON H-5 CHANNEL 3

### LIGHTING PLAN KEYED NOTES:

- NIGHT LIGHTS, EXIT SIGNS AND EMERGENCY LIGHTING SHALL BE CONNECTED TO LOCAL CIRCUIT AHEAD OF SWITCH WHERE REQUIRED BY THE LOCAL AUTHORITY HAVING JURISDICTION.
   NIGHT LIGHT FIXTURE TO BE POWER BY NIGHT LIGHT CIRCUIT FOR 24 HOUR OPERATION. CONTRACTOR TO COORDINATE LOCATION AND QUANTITY OF NIGHT LIGHT FIXTURES
- REQUIRED BY TENANT AND AUTHORITY HAVING JURISDICTION.

  TIME CLOCK FOR CONTROL OF EXTERIOR LIGHTING AND SIGNAGE. COORDINATE
- TIME CLOCK FOR CONTROL OF EXTERIOR LIGHTING AND SIGNAGE. COORDINATE REQUIREMENTS AND CIRCUITING WITH BUILDING OWNER. SET ON/OFF TIMES AS REQUIRED BY BUILDING OWNER.
- (4) VERIFY CIRCUITING AND ON/OFF TIMES FOR SIGNAGE FIXTURES WITH OWNER.
- ELEVATOR EQUIPMENT ROOM EXHAUST FAN GREENHECK SP-B110-QD, 95CFM, CONTROLLED VIA THERMOSTAT SHOWN. SET THERMOSTAT FOR FAN OPERATION ABOVE 80°F. PROVIDE RELIEF AIR WITH FIRE DAMPER COORDINATED WITH FIRST FLOOR AIR CONDITIONING WHEN INSTALLED. SEE 2/P-2 FOR EXHAUST DUCT ROUTING.
- 6 L7 FIXTURES TO BE SET FOR DUSK TO DAWN OPERATION VIA TIME CLOCK. FIXTURES SHALL ONLY ILLUMINATE BETWEEN DUSK AND DAWN WHEN ACTIVATED BY MOTION DETECTOR.

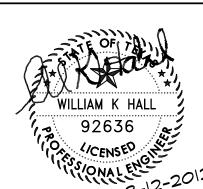


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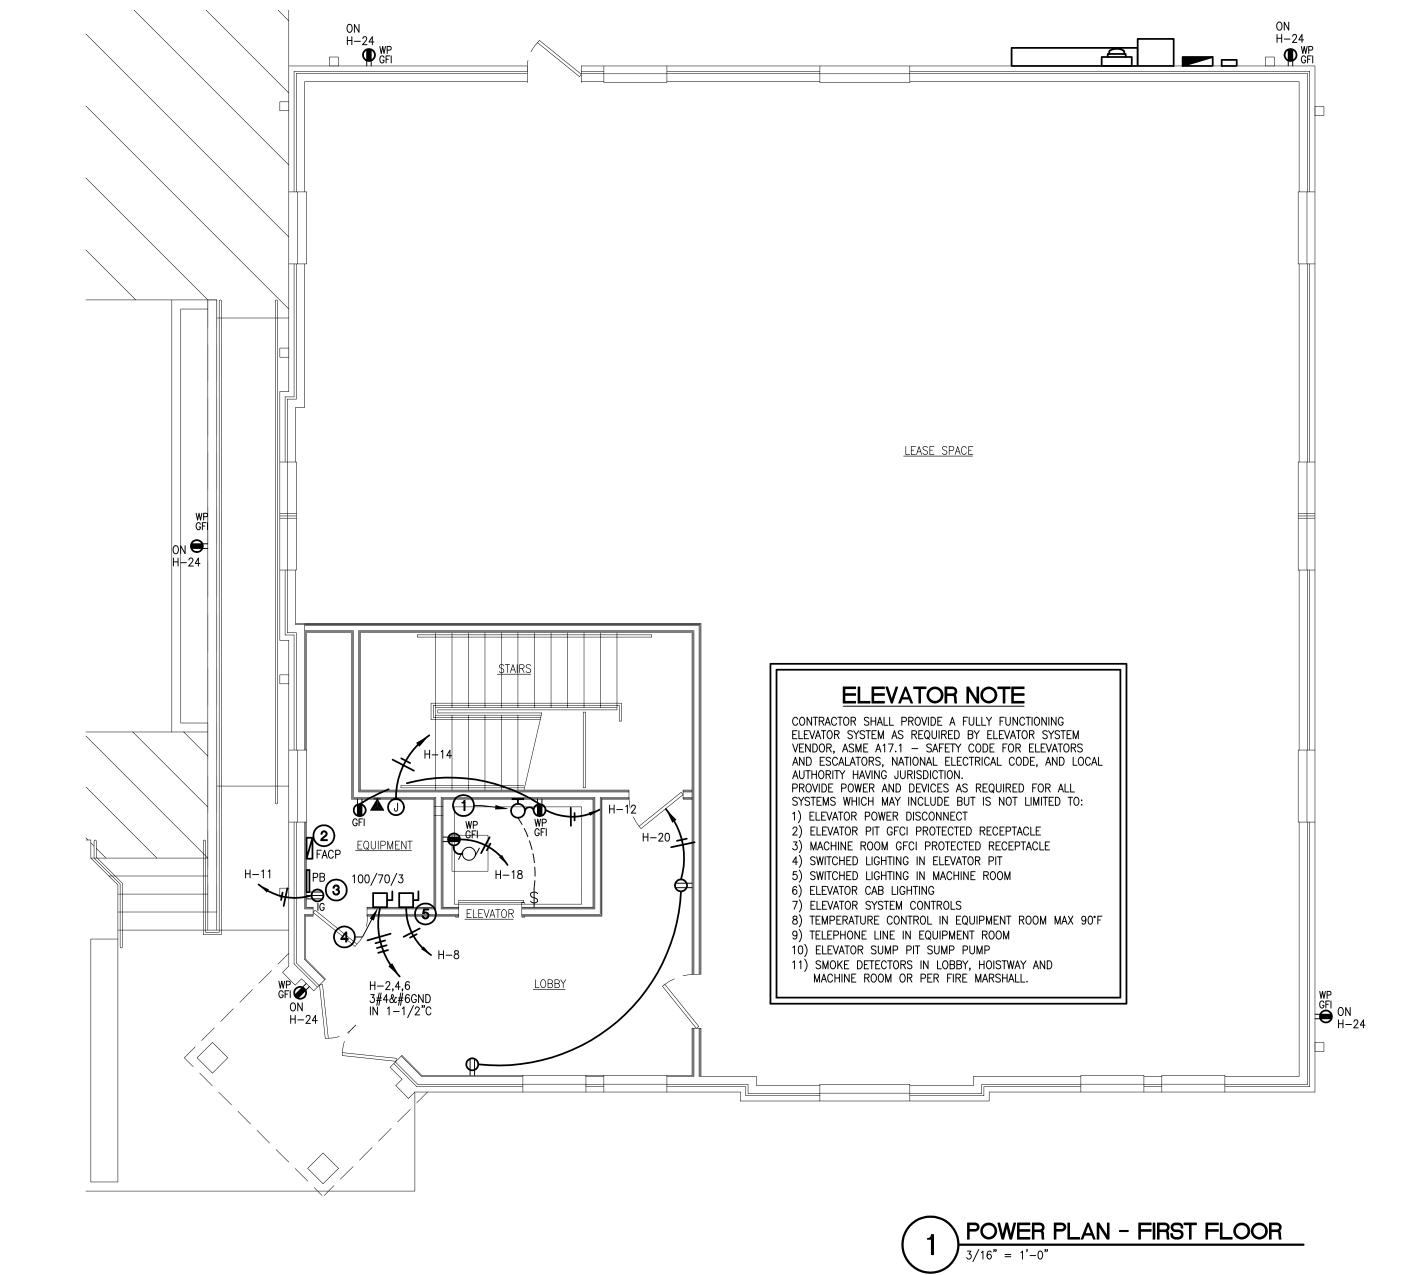
Project No.

Dwg. Name

ELECTRICAL POWER PLANS

Dwg. No.



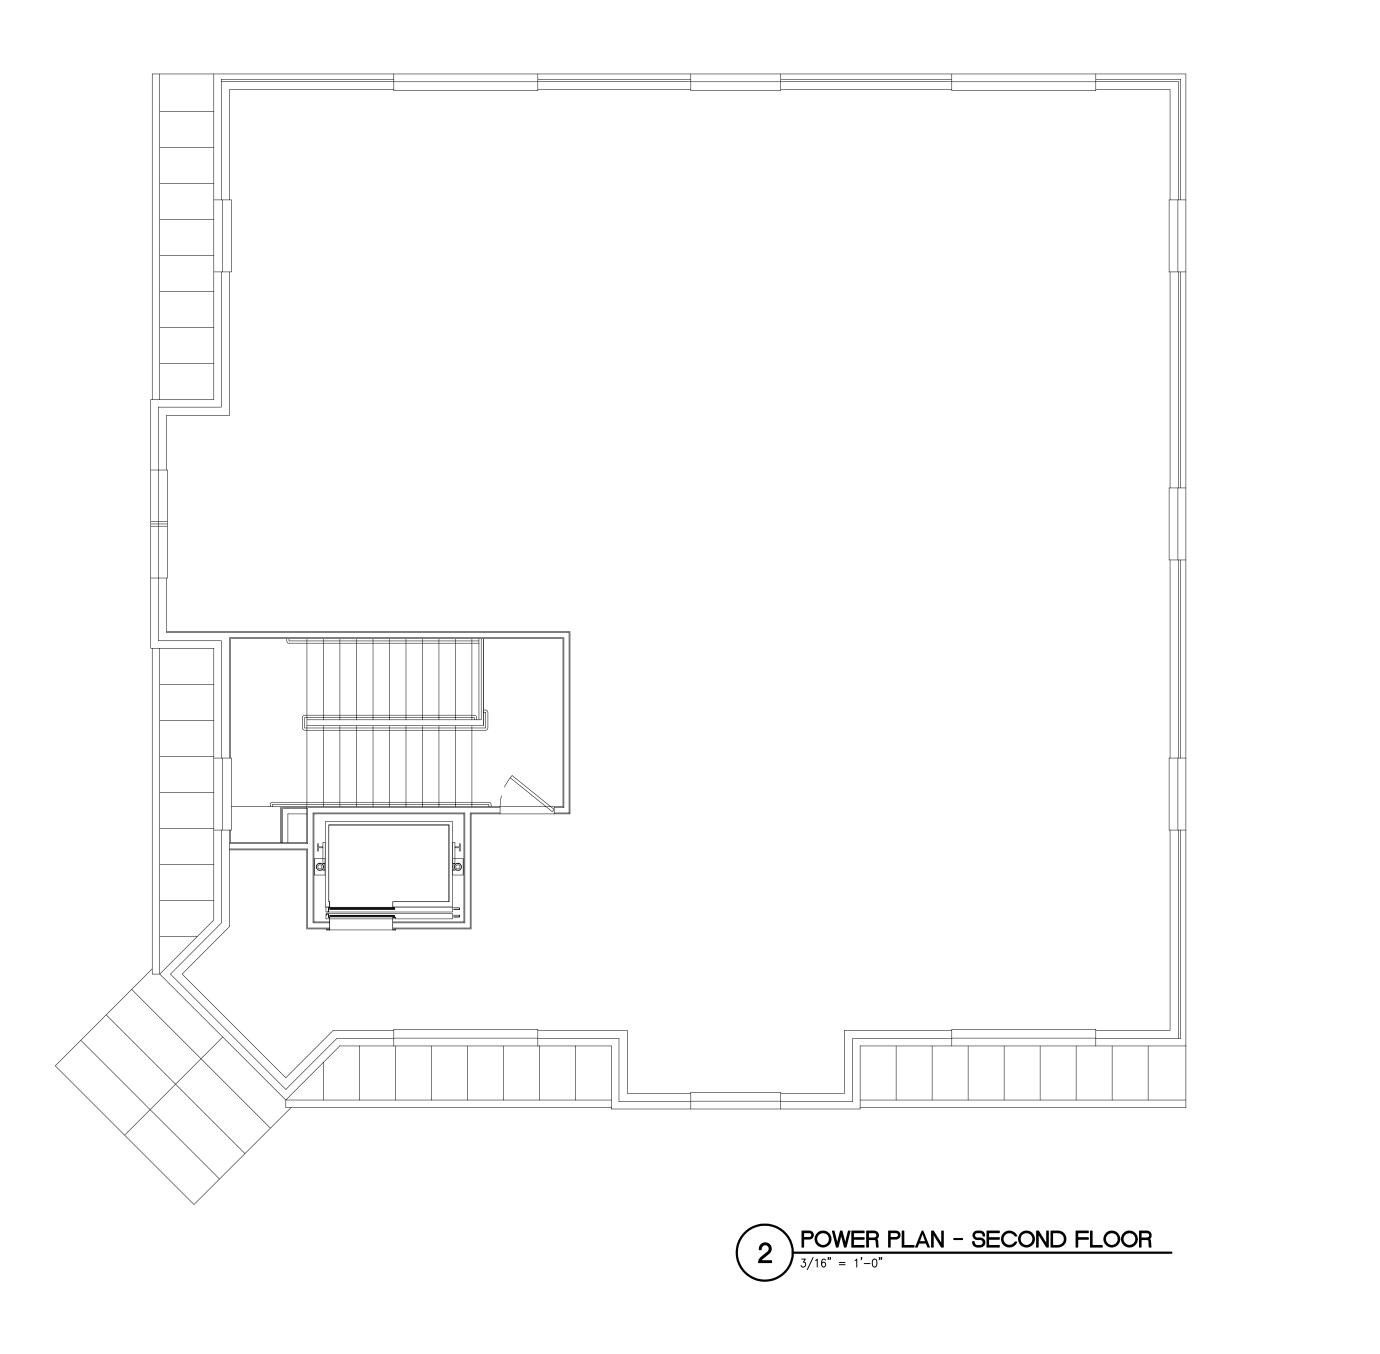

- 1. CONTRACTOR IS RESPONSIBLE FOR FIELD VERIFICATION OF ALL CONDITIONS AND IS RESPONSIBLE FOR REPORTING ANY CONFLICTS TO THE ARCHITECT PRIOR TO THE START
- 2. "EXISTING" OR "VERIFY IN FIELD" MEANS THE CONTRACTOR IS TO CONFIRM THE ITEM SHOWN ON THE DRAWING EXISTS AND IS IN GOOD WORKING CONDITION. SHOULD THE INSTALLED AS REQUIRED TO PROVIDE THE OWNER WITH A FULLY FUNCTIONING SYSTEM AND AS REQUIRED BY ALL LOCAL CODES AND THE LOCAL AUTHORITY HAVING
- ACCORDANCE WITH ALL PERTINENT CODES AND REGULATIONS.
- 4. ELECTRICAL CONTRACTOR SHALL MAKE FINAL CONNECTIONS TO ALL ELECTRICALLY

DISCONNECT SWITCH LEGEND

QUANTITY OF POLES

——SWITCH RATING (TERMINALS)

——FUSE RATING

**—** #/#/#

- 5. THE CONTRACTOR SHALL BE RESPONSIBLE FOR ANY DAMAGE TO THE BUILDINGS STRUCTURE OR UTILITIES CAUSED BY SLAB PENETRATIONS. IT IS RECOMMENDED THAT
- 6. CONTRACTOR SHALL COMPLY WITH THE LATEST APPROVED NATIONAL ELECTRICAL CODE AND OSHA'S FAULT PROTECTION STANDARD ON THE CONSTRUCTION SITE.
- CONDUIT SHALL BE CONCEALED. EXPOSED SECURITY SYSTEM CONDUIT SHALL NOT BE ALLOWED. VERIFY REQUIREMENTS WITH OWNER PRIOR TO FINAL BID.
- 8. CONTRACTOR SHALL REFER TO ELECTRICAL SPECIFICATIONS WITHIN THIS SUBMITTAL FOR ADDITIONAL REQUIREMENTS.

### **ELECTRICAL GENERAL NOTES:**

- CONTRACTOR FIND THE EQUIPMENT IS NOT AS SHOWN ON THESE DRAWINGS, IT IS TO BE
- 3. THE CONTRACTOR SHALL PROVIDE A COMPLETE, USEABLE, AND OPERABLE FACILITY IN
- THE CONTRACTOR X-RAY THE FLOOR PRIOR TO ANY SLAB PENETRATIONS.
- 9. VOLTAGE DROP THRU ALL CONDUCTORS SHALL NOT EXCEED THAT ALLOWED BY THE NEC. CONTRACTOR SHALL UPSIZE FEEDERS AND BRANCH CIRCUITS AS REQUIRED WHERE REQUIRED.

- ENERGIZED EQUIPMENT WHETHER FURNISHED BY CONTRACTOR OR OWNER AND SHALL MEET THE LATEST APPROVED NATIONAL ELECTRICAL CODE (N.E.C.) FOR THE AREA.
- 7. CONTRACTOR SHALL PROVIDE EMPTY CONDUIT WITH PULL STRING FOR SECURITY SYSTEM WIRING BY OWNERS SECURITY SYSTEM VENDOR 1/2" MINIMUM. ALL SECURITY SYSTEM


## POWER PLAN KEYED NOTES:


- (1) KEYLESS PORCELAIN SOCKET WITH 100W A19 LAMP AND WIRE GUARD. INSTALL IN ELEVATOR PIT AT EACH LEVEL.
- PROVIDE FIRE ALARM CONTROL PANEL (FACP) AS REQUIRED BY LOCAL FIRE MARSHALL. REFER TO "FIRE ALARM NOTE" THIS SHEET FOR ADDITIONAL INFORMATION.
- 3 TELEPHONE BOARD OR DEMARK CABINET. REFER TO SITE PLAN FOR ADDITIONAL INFORMATION AND REQUIREMENTS.
- ELEVATOR CONTROLLER FUSED DISCONNECT SWITCH WITH TIME DELAY FUSES. PROVIDE SEPARATE INSULATED GROUNDING CONDUCTOR WITH FEEDER CONDUCTORS TO ELEVATOR CONTROLLER. CONTRACTOR MUST VERIFY ELEVATOR MANUFACTURER, MODEL, AND SPECIFICATIONS WITH ELEVATOR SUPPLIER. INSTALL DISCONNECT SWITCH WITH FUSES AND FEEDERS AS REQUIRED BY ELEVATOR SYSTEM SUPPLIED AND ELEVATOR MANUFACTURER. INSTALLATION AS REQUIRED BY NEC ARTICLE 430.
- (5) FUSED DISCONNECT SWITCH FOR ELEVATOR CAB LIGHTS, 30/20/1.

## FIRE ALARM NOTE:

A FIRE ALARM SYSTEM THAT MEETS CURRENT NFPA FIRE CODE WILL BE INSTALLED BY A LICENSED QUALIFIED FIRE SAFETY CONTRACTOR. THIS COMPANY WILL SUBMIT A PLAN TO THE TOWN FIRE MARSHAL'S OFFICE FOR APPROVAL PRIOR TO INSTALLATION.

THE GENERAL CONTRACTOR AND ELECTRICAL SUB-CONTRACTOR SHALL VERIFY AND INCLUDE IN THEIR FINAL BID ALL LIFE SAFETY, SMOKE/FIRE ALARM SYSTEMS REQUIRED TO PROVIDE A FACILITY CURRENT WITH THE LOCAL FIRE MARSHALS REQUIREMENTS, ALL LOCAL CODES, ALL STATE CODES AND THE AUTHORITY HAVING JURISDICTION.

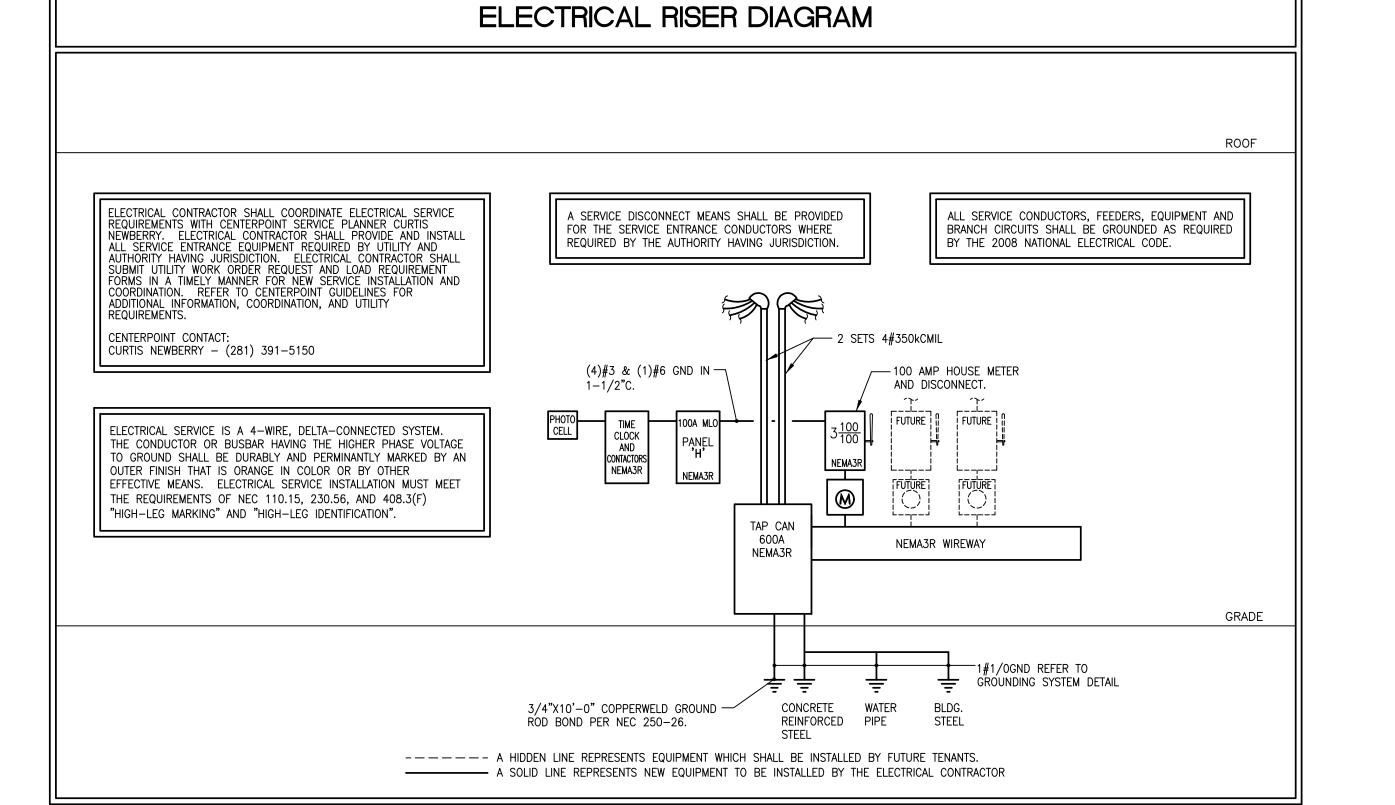

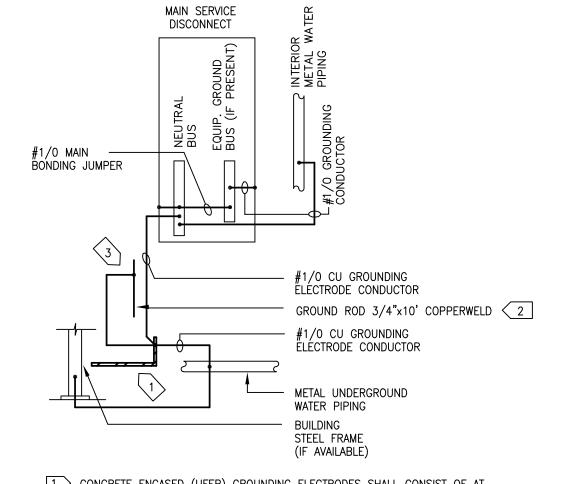

1 CONCRETE ENCASED (UFER) GROUNDING ELECTRODES SHALL CONSIST OF AT LEAST 20 FEET OF ONE OR MORE STEEL REINFORCING BARS OR RODS. BARS SHALL BE NOT LESS THAN 1/2 INCH DIAMETER. IN LIEU OF RODS OR BARS, AT LEAST 20 FEET OF BARE COPPER CONDUCTORS NOT SMALLER THAN No. 4 AWG MAY BE USED. UFER GROUND SHALL BE ENCASED BY AT LEAST 2 INCHES OF CONCRETE AND LOCATED WITHIN AND NEAR THE BOTTOM OF A CONCRETE FOUNDATION OR FOOTING THAT IS IN DIRECT CONTACT WITH THE EARTH.

- 2 GROUND RODS SHALL BE 3/4" DIA. X 10' LONG COPPERWELD. RESISTANCE TO GROUND MUST BE 25 OHMS OR LESS.
- 3 GROUNDING ELECTRODE CONNECTIONS SHALL BE MADE WITH A U.L. LISTED AND APPROVED BOLTED PRESSURE OR COMPRESSION TYPE CONNECTOR.

GROUNDING SYSTEM DETAIL

Al	N	BUS MAINS	E: 240/120 3ø 4W S: 100A S: 100A MLO S: 65,000						(S	<b>PA</b> URFACE				<b>'H'</b> NEMA3R	)					C : CONTINUOUS N : NON—CONTII K : KITCHEN EC	NUOUS (1		
NO		ш	LOAD DESIGNATION CONNECTED VA				LOAD DESIGNATION				<b> </b> ш	NO											
CKT	TRP	POLE	DESCRIPTION (	(NOTE)	С	N	К	ØΑ	ØВ	ØС	A	В	С	ØΑ	ØВ	ØС	К	N (	) (N	OTE) DESCRIPTION	TRIP	집	, j
1			EMERG, EXIT AND 24HR LT	TG (5)	X			430			1→	+	+	4300				<b>X</b>	(3)	ELEVATOR POWER	150		2
3			SPACE	(7)							$\rightarrow$	+	+		4300			<b>र</b>	(3)				4
5	20	1	LTG - EXTERIOR	2	X					430	$\mathbb{H}$	+	+			4300		<b>₹</b>	3	•		3	6
7	20	1	LTG - LOBBY	(2)	X			236			}	+	+	300				$\supset$	<u> </u>	ELEVATOR LIGHTS	20	1	8
9			SPACE	7							$\mathbb{H}$	+	+						7	SPACE			10
11	20	1	TELEPHONE BOARD			$\times$				200	brack	-	+			360		$\langle  $		EQUIP/PIT GFCI REC	20	1	12
13	20	1	SPARE								<b>}</b>	+	+	500				$\langle$		ELEVATOR CONTROL	20	1	14
5			SPACE	7							$\rightarrow$	+	+						7	SPACE			1
			SPARE								$\vdash$		+			400		$\langle \  $		ELEVATOR PIT SUMP	20	_	1
	20	1	SPARE											360				$\leq$		RECEPTACLES (2)	20	1	2
21			SPACE	7															7	SPACE			2
	20		SPARE								╛╽					900		$\leq$		RECEPTACLES (5)	20		2
25	20	1	SPARE																	SPARE	20	1	2
27			SPACE	(7)							4								7	SPACE			2
29	20	1	SPARE																	SPARE	20	1	3
_	<del></del>			PHA	SE 1	OTA	LS	øA =	6,126	Q	øB =	= 4,	,300	)	$\phi C = 6$ ,	590			T	OTAL CONNECTED VA	17,0	16	
	_		OTES:			_													CON	NECTED VA (CODE C)	1,3	96	
- 3	=		IDE SWITCH TYPE CIRCUIT E															$\vdash$	CON	NECTED VA (CODE N)	15,6	20	
•	_		JIT CONTROLLED VIA TIME C			PHOT	OCE	_L. PRO	OVIDE EN	ICLOSUF	SE N	NEAR	R PA	NEL.				$\vdash$		· ,	10,0		
(	3)	PROV	IDE INVERSE TIME CIRCUIT E	BREAKE	R.													$\vdash$		NECTED VA (CODE K)		0	
(	4)	PROV	'IDE " GFI " TYPE CIRCUIT E	BREAKE	R.														PA	NEL CONNECTED KVA	17	7.0	
(	5)	PROV	IDE BREAKER WITH LOCK-O	ON DEVI	CE															PANEL DEMAND KVA	17	7.4	
(	6)	PROV	VIDE CIRCUIT WITH ISOLATED	GROUN	ID.															PANEL DEMAND AMPS	41	1.9	
7	7)	חחטי	IDE SPACE FOR 208V HIGH			- "-	,"											$\vdash$		HIGH Ø AMPS W/LCL		1.9	_

\* = COORDINATE AND VERIFY OVERCURRENT DEVICE WITH ELEVATOR MANUFACTURER AND FINAL ELEVATOR SELECTION BY OWNER.


Kashou architecture

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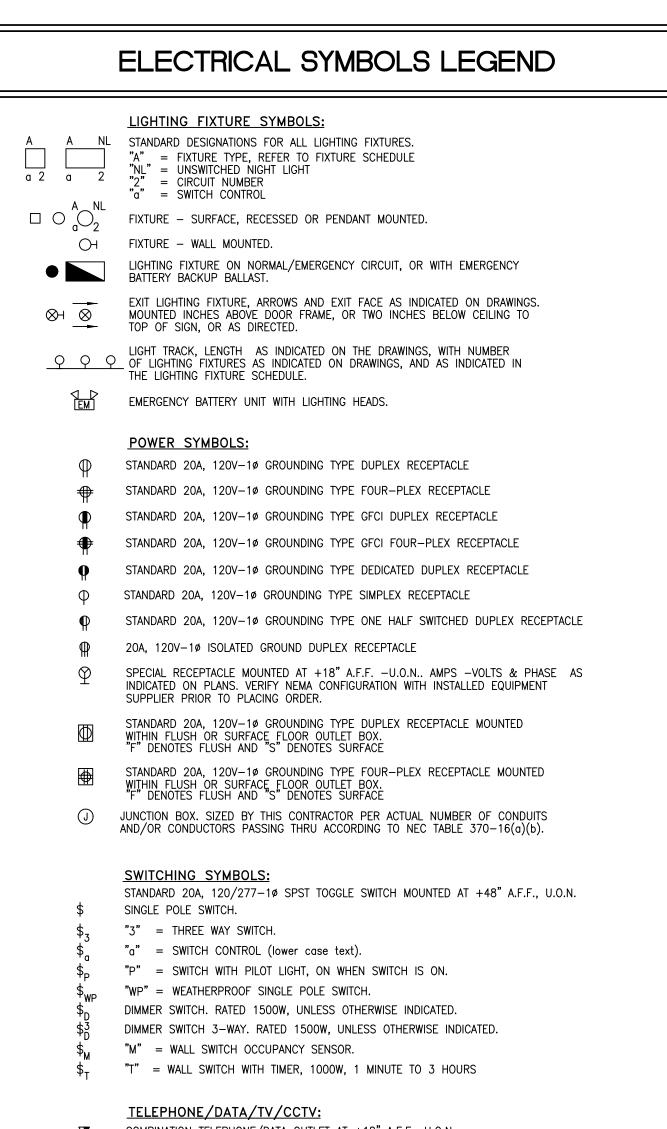


03/12/2012

Project No.

Dwg. Name

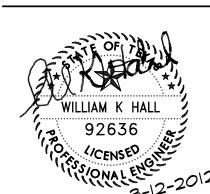ELECTRICAL PANELS AND RISER DIAGRAM



- COMBINATION TELEPHONE/DATA OUTLET AT +18" A.F.F., U.O.N. PROVIDE 1" CONDUIT STUB-UP 6" MINIMUM INTO ACCESSIBLE CEILING SPACE.
- TELEPHONE OUTLET AT +18" A.F.F., U.ON. PROVIDE 1" CONDUIT STUB-UP 6" MINIMUM INTO ACCESSIBLE CEILING SPACE.
- DATA OUTLET AT +18" A.F.F., U.ON. PROVIDE 1" CONDUIT STUB-UP 6" MINIMUM INTO ACCESSIBLE CEILING SPACE.
- COMBINATION TELEPHONE/DATA OUTLET MOUNTED WITHIN FLUSH OR SURFACE OUTLET BOX. "F" DENOTES FLUSH AND "S" DENOTES SURFACE
- TELEVISION AND/OR CCTV OUTLET AS DIRECTED BY OWNER AT +18" A.F.F., U.O.N.

### PANELBOARD, TERMINAL CABINETS & OTHER:

LIGHTING OR POWER PANEL, RECESSED. LIGHTING OR POWER PANEL, SURFACE.

DISCONNECT SWITCH, UNFUSED TYPE, SIZE AS INDICATED ON DRAWINGS.

30A/NF/3 □ DISCONNECT SWITCH, FUSED TYPE, SIZE AS INDICATED ON DRAWINGS.

30A/20A/3 📈 (30AMP, 20AMP FUSE, 3POLE)

THERMOSTAT

PHOTO-ELECTRIC CELL

TIME CLOCK WITH MANUAL BY PASS, WITH HAND-OFF-AUTO SELECTOR SWITCH.

PULLBOX - SIZE AS INDICATED OR REQUIRED.

2"C 4#1 & 1#6GND INDICATES 2" CONDUIT WITH 4#1AWG AND 1#6AWG GROUND.

(2)2"C 4#1 & 1#6GND INDICATES (2)2" CONDUITS WITH 4#1AWG AND 1#6AWG GROUND. CONDUCTORS IN EACH CONDUIT.

### **ELECTRICAL ABBREVIATIONS**

A AFF C CATV CKT CB CU E DWG EC EWC EMT EX FA G,GND GC GFI GFIP HVAC HP IG JB	AMPERE ABOVE FINISHED FLOOR OR GRADE CONDUIT OR RACEWAY CABLE TELEVISION CIRCUIT CIRCUIT BREAKER COPPER CENTERLINE DRAWING ELECTRICAL SYSTEM INSTALLER ELECTRIC WATER COOLER ELECTRICAL METALLIC TUBING EXISTING FIRE ALARM GROUND GENERAL CONTRACTOR GROUND FAULT INTERRUPTER GROUND FAULT INTERRUPTER PROTECTED EQUIPMENT HEATING, VENTILATING AND AIR CONDITIONING INSTALLER HORSEPOWER ISOLATED GROUND JUNCTION BOX	kCMIL kVA kW LTG MCB MDP MLO MTD MTG NIC NO # NTS PB PH Ø PC PVC PWR RGS TD TYP U.O.I. WP XFMR	THOUSAND CIRCULAR MILS KILO-VOLT AMPERE KILO-WATT LIGHTING MAIN CIRCUIT BREAKER MAIN DISTRIBUTION PANEL MAIN LUGS ONLY MOUNTED MOUNTING NOT IN CONTRACT NUMBER NOT TO SCALE PULLBOX PHASE PLUMBING SYSTEM INSTALLER POLY-VINYL CHLORIDE CONDUIT POWER RIGID GALVANIZED STEEL TELEPHONE/DATA TYPICAL UNLESS OTHERWISE INDICATED WEATHERPROOF TRANSFORMER
		I	

### BASIC ELECTRICAL REQUIREMENTS

THE CONTRACTOR SHALL PROVIDE ALL MATERIALS, LABOR, TOOLS, PLANT, INCIDENTALS AND CONTRACTUAL EXPENSES NECESSARY TO INSTALL AND MAKE READY FOR OWNER'S USE A COMPLETE ELECTRICAL SYSTEM AS CALLED FOR IN THE CONTRACT DOCUMENTS AND AS NOTED OR SPECIFIED HEREIN. TO THE SATISFACTION OF THE OWNER, ARCHITECT AND ELECTRICAL ENGINEER.

B. THE CONTRACTOR SHALL FURNISH AND INSTALL ALL WORK NECESSARY TO MAKE A COMPLETE SYSTEM WHETHER OR NOT SUCH DETAILS ARE MENTIONED IN THESE SPECIFICATIONS AS SHOWN ON THE PLANS, BUT WHICH ARE OBVIOUSLY NECESSARY TO MAKE A COMPLETE SYSTEM. EXCEPTING ONLY THOSE PORTIONS THAT ARE SPECIFICALLY MENTIONED HEREIN OR PLAINLY MARKED ON THE ACCOMPANYING DRAWINGS AS BEING INSTALLED UNDER ANOTHER SECTION OF THE SPECIFICATIONS.

BEFORE STARTING ANY WORK. THE CONTRACTOR FOR THIS SECTION OF THE WORK SHALL EXAMINE A COMPLETE SET OF DRAWINGS AND SPECIFICATIONS FOR ALL TRADES, INCLUDING ARCHITECTURAL, STRUCTURAL, HVAC, ELECTRICAL, FIRE PROTECTION, AND PLUMBING. DIMENSIONS, SPACE REQUIREMENTS, AND POINTS OF CONNECTION TO ALL EQUIPMENT SHALL BE VERIFIED, AND ANY MINOR ADJUSTMENTS NECESSARY TO AVOID CONFLICT WITH THE BUILDING STRUCTURE AND THE WORK OF THE OTHER TRADES SHALL BE MADE. CONTRACTOR SHALL NOTIFY ARCHITECT IMMEDIATELY IF ANY MAJOR CONFLICTS

E2- WORKMANSHIP: ALL WORK SHALL BE PERFORMED BY COMPETENT ELECTRICIANS USING PROPER TOOLS AND EQUIPMENT TO PRODUCE FIRST-QUALITY WORK. ALL WORK SHALL BE NEATLY INSTALLED, ACCESSIBLE FOR MAINTENANCE, COMPLETE WITH ALL ACCESSORIES REQUIRED, AND MEETING THE

E3- MATERIALS: ALL PRODUCTS, EQUIPMENT, MATERIALS, AND ACCESSORIES SHALL BE OF FIRST-LINE QUALITY, GRADE AND TYPE SHOWN ON THE DRAWINGS AND SPECIFIED, OR EQUIVALENTS ACCEPTED BY THE ARCHITECT OR ENGINEER IN WRITING.

APPROVAL OF THE OWNER AND THE ARCHITECT

E4- SITE INSPECTION:
CONTRACTOR SHALL VISIT THE JOB SITE PRIOR TO SUBMITTING HIS BID AND THOROUGHLY FAMILIARIZE HIMSELF WITH ALL EXISTING CONDITIONS AND EXACT NATURE OF THE WORK. THE DRAWINGS ARE ESSENTIALLY DIAGRAMMATIC. SUBMISSION OF A BID ACKNOWLEDGES FULL RESPONSIBILITY FOR FURNISHING A COMPLETE AND FUNCTIONAL SYSTEM. NO CHANGES IN CONTRACT WILL BE MADE TO ACCOMMODATE OR ALLOW EXTRA FUNDS FOR ANY OMISSION WHICH RESULTS FROM A FAILURE TO THOROUGHLY MAKE THE EXAMINATION.

THE ENTIRE INSTALLATION SHALL CONFORM TO THE REQUIREMENTS OF THE LATEST APPLICABLE EDITION OF THE CODES, ORDINANCES AND REGULATIONS INTERPRETED BY THE LOCAL AUTHORITY HAVING JURISDICTION. IN ADDITION THE INSTALLATION SHALL CONFORM TO THE FOLLOWING REQUIREMENTS OF THE FOLLOWING CODES AND STANDARDS. A. REQUIREMENTS OF THE NATIONAL ELECTRICAL CODE, LATEST ADOPTED EDITION.

B. REQUIREMENTS OF STATE FIRE MARSHAL, STATE AND MUNICIPAL BUILDING AND ELECTRICAL SAFETY ORDINANCES.

C. ALL PRODUCTS IN THIS WORK SHALL BE UL LABELED AND SHALL CONFORM TO ALL REQUIREMENTS OF THE NATIONAL BOARD OF FIRE UNDERWRITERS FOR FLECTRICAL WIRING APPARATUS

D. REQUIREMENTS OF ALL OTHER AUTHORITIES HAVING JURISDICTION.

E6- PERMITS: THE CONTRACTOR SHALL OBTAIN AND PAY FOR ALL PERMITS, INSPECTIONS AND FEES. COPIES OF ALL PERMITS AND INSPECTION REPORTS SHALL BE SUBMITTED TO THE ARCHITECT.

E7- AS-BUILTS: CONTRACTOR SHALL PROVIDE A COMPLETE SET OF AS-BUILTS TRANSPARENCIES WITH ALL CHANGES NOTED THEREON AT THE COMPLETION OF THE PROJECT AND PRIOR TO FINAL ACCEPTANCE AND PAYMENT. THESE DRAWINGS SHALL HAVE ALL INSTALLATIONS REFERENCED BY DIMENSIONS TO A SET REFERENCE POINT OR POINTS.

CONTRACTOR SHALL UNCONDITIONALLY GUARANTEE ALL LABOR AND MATERIALS ON ALL WORK AGAINST DEFECTS IN WORKMANSHIP AND MATERIALS FOR A PERIOD OF ONE YEAR AFTER COMPLETION. CONTRACTOR SHALL BE RESPONSIBLE FOR ALL DAMAGE TO ANY PART OF THE PREMISES CAUSED BY EQUIPMENT FURNISHED AND INSTALLED UNDER THIS SECTION OF THE SPECIFICATIONS FOR A PERIOD OF ONE (1) YEAR AFTER DATE OF ACCEPTANCE OF HIS WORK

CONTRACTOR SHALL FURNISH THE OWNER WITH ALL OPERATING MANUALS AND MAINTENANCE INSTRUCTIONS FOR THE EQUIPMENT INSTALLED. MANUALS SHALL BE BOUNDED IN THREE RING LOOSE-LEAF BINDERS AND INDEXED BY PRODUCT TYPE. A SECTION WITHIN THE MANUAL SHALL INCLUDE THE NAME. TELEPHONE NUMBER AND ADDRESS OF ALL LOCAL SUPPLIERS OF ALL MATERIAL AND FOLIPMENT INSTALLED TOGETHER WITH NAME. TELEPHONE NUMBER AND ADDRESS OF ALL CONTRACTORS OF THE PROJECT. PROVIDE 3 SETS OF MANUALS TO THE OWNER. CONTRACTOR SHALL AFFIX A MAINTENANCE LABELS TO ALL EQUIPMENT REQUIRING ROUTINE MAINTENANCE.

E10- COORDINATION AND VERIFICATION: THE DRAWINGS ARE DIAGRAMMATIC AND INTENDED TO SHOW SCOPE. THE CONTRACTOR SHALL COORDINATE HIS WORK WITH OTHER TRADES TO PROVIDE THE BEST ARRANGEMENT OF ALL DUCTS, PIPES, CONDUIT, ETC... THE LOCATION OF EXISTING PIPING AND DUCTWORK SHOWN IS APPROXIMATE. CONTRACTOR SHALL VERIFY THEIR LOCATION PRIOR TO BEGINNING WORK OF THIS SECTION AND SHALL MAKE MODIFICATIONS AND ADJUSTMENTS REQUIRED TO INSTALL THE WORK OF

A. VERIFY AND COORDINATE ALL SIZES OF EQUIPMENT TO BE INSTALLED WITHIN ROOMS WITH THE MANUFACTURER OF EQUIPMENT, INSURING ADEQUATE

CLEARANCES, VENTILATION AND ACCESS. B. COORDINATE WORK OF MECHANICAL TRADES FOR WORK REQUIRED AS PART OF

THIS SECTION, AND VERIFY QUANTITY, SIZES AND LOCATION OF ALL WORK. C. COORDINATE THE WORK OF ALL OTHER TRADES, VERIFYING ALL REQUIRED

CLEARANCES, PROPER SLEEVES, SUPPORTS, DOOR SWINGS AND OTHER ITEMS AFFECTING THIS WORK. DETERMINE IN ADVANCE THE METHODS OF INSTALLING

AND CONNECTION OF ALL EQUIPMENT, OUTLETS AND OTHER ITEMS. D. INCLUDE ALLOWANCES FOR SITE CONDITIONS AND CIVIL, ARCHITECTURAL AND OTHER DRAWINGS.

ALL OPENINGS WITH APPROPRIATE EQUIPMENT REQUIREMENTS.

E11- EXTERIOR OPENINGS: COORDINATE LOCATIONS OF ALL EXTERIOR WALL AND ROOF OPENINGS WITH ALL RELEVANT TRADES AND PROVIDE WATERTIGHT FLASHINGS WHEREVER PENETRATIONS OCCUR. EXACT LOCATIONS AND SIZES MAY BE DEPENDENT UPON EQUIPMENT SELECTIONS. COORDINATE SIZES AND LOCATIONS OF

E12- CUTTING AND PATCHING: ALL CUTTING CHASING AND CHANNELING REQUIRED FOR ANY WORK UNDER THIS DIVISION SHALL BE BY THE CONTRACTOR. CUTTING SHALL HAVE PRIOR APPROVAL OF THE LANDLORD. ALL PATCHING SHALL BY G.C. AND SHALL MATCH THE SURROUNDING SURFACES.

E13- EQUIPMENT ACCESS: ALL WORK IN THIS SECTION SHALL BE INSTALLED SO AS TO BE READILY ACCESSIBLE FOR OPERATING, SERVICING, MAINTAINING, AND REPAIRING. THIS CONTRACTOR IS RESPONSIBLE FOR

PROVIDING SUFFICIENT SERVICE ACCESS TO ALL EQUIPMENT. E14— TEMPORARY LIGHT AND POWER:

THIS CONTRACTOR SHALL FURNISH AND INSTALL ALL TEMPORARY WIRING AND RELATED GROUND FAULT INTERRUPTION PROTECTION FOR LIGHTING AND POWER FOR ALL CONTRACTORS AND IS

PROVIDE SLEEVES OF SUFFICIENT SIZE TO PERMIT READY INSTALLATION OF EACH CONDUIT WHICH PASSES THROUGH WALLS OR SUSPENDED SLABS. SLEEVES IN CONCRETE BEAMS, JOISTS, COLUMNS OR FOOTING WALLS MAY BE INSTALLED ONLY WHERE PERMITTED BY THE STRUCTURAL ENGINEER. EACH SLEEVE SHALL EXTEND THROUGH IT'S RESPECTIVE FLOOR. WALL OR PARTITION AND SHALL BE CUT FLUSH WITH EACH SURFACE EXCEPT SLEEVES THAT PENETRATE THE FLOOR, WHICH SHALL EXTEND 1" ABOVE THE FLOOR. CONTRACTOR MUST COORDINATE THROUGH THE LANDLORD ANY CORE DRILLING OR CUTTING OF OPENINGS IN MASONRY WALLS OR FLOORS. ALL SLEEVES AND OPENINGS THROUGH FIRE RATED WALLS AND FLOORS SHALL BE FIRE SEALED WITH CALCIUM SILICATE. SILICONE "RTV" FOAM, "3M" FIRE RATED SEALANT OR EQUAL, SO AS TO RETAIN THEIR FIRE RATING. WHERE A CONDUIT PASSES THROUGH AN EXTERIOR SURFACE, SEAL THE SPACE BETWEEN THE CONDUIT AND ITS SLEEVE WITH AN APPROVED WATER TIGHT COMPOUND.

PANELBOARDS SHALL BE FACTORY ASSEMBLED OF THE BOLTED CIRCUIT BREAKER TYPE WITH SOLID COPPER BUSSING, FULL SIZE COPPER NEUTRAL, 100% GROUND BUSSING AND OVERALL LOCKABLE HINGED DOOR. ALL PANELS SHALL BE DEAD FRONT AND FLUSH OR SURFACE MOUNTED AS SHOWN. A. CONTRACTOR SHALL FURNISH AND INSTALL A TYPEWRITTEN DIRECTORY CARD OF THE CIRCUITS AND PLACE IN PANEL DOOR. CIRCUIT NUMBERS SHALL BE ON

BLACK-ON-WHITE LAMINATED TABS OR OTHER PERMANENT TYPE NOT READILY CHANGED FROM THE FRONT. B. ALL PANELBOARDS PHASE AMPERAGE SHALL BE BALANCED TO WITHIN 10%

MAXIMUM TO MINIMUM. C. VERIFY ACTUAL A.I.C. SHORT CIRCUIT CURRENT REQUIREMENTS WITH THE LANDLORD OR UTILITY COMPANY AND VERIFY SWITCHGEAR COMPLIANCE PRIOR TO PURCHASE OR INSTALLATION OF FOUIPMENT.

D. LUGS SHALL BE SUITABLE FOR COPPER CONDUCTORS

### **ELECTRICAL SPECIFICATIONS**

E17- CIRCUIT BREAKERS: LL CIRCUIT BREAKERS SHALL BE OF THE BOLTED TYPE, QUICK-MAKE AND QUICK BREAK DESIGN,

THERMAL MAGNETIC TYPE, TRIP FREE AND TRIP-INDICATING. VOLTAGE RATING SHALL BE AS REQUIRED FOR THE APPLICATION. ALL CIRCUIT BREAKERS WHICH ARE LOCATED OUTSIDE OF AIR CONDITIONED SPACES SHALL BE AMBIENT COMPENSATED. USE "HACR" CIRCUIT BREAKERS FOR AIR CONDITIONING LOADS. USE "SWD" CIRCUIT BREAKERS FOR LIGHTING

CIRCUITS CONTROLLED FROM THE PANEL. ALL BRANCH BREAKERS SHALL BE ABLE TO ACCOMMODATE LOCKOUT CLIPS. PROVIDE CLIPS TO LOCK BREAKERS SERVICING EMERGENCY LIGHTING, MOTORS, REFRIGERATORS AND CONTROLS FOR MECHANICAL SYSTEMS. ARRANGE ALL BREAKERS TO CORRESPOND EXACTLY WITH PANEL SCHEDULES.

TRANSFORMERS SHALL BE DRY TYPE, INDOOR OR OUTDOOR, SELF-COOLED TYPE WITH 150°C TEMPERATURE RISE UNDER FULL LOAD CONDITIONS. TRANSFORMER SHALL BE PAD MOUNTED OR BE SECURELY MOUNTED FROM THE BUILDING STRUCTURE, REINFORCED WALLS OR AS NOTED ON THE DRAWINGS. USE VIBRATION ISOLATORS AT POINTS OF MOUNTING TO REDUCE VIBRATION NOISES. USE FLEXIBLE METALLIC CONDUIT WITH GROUNDING BUSHING FOR PRIMARY AND SECONDARY CONNECTIONS TO TRANSFORMER. TRANSFORMER SHALL BE INSTALLED TO MAINTAIN ALL CODE REQUIRED CLEARANCES. TRANSFORMER SHALL BE QUIET TYPE CONSTRUCTION AND HAVE FOUR 2-1/2% FULL CAPACITY TAPS.

E19- CONDUIT: UNLESS OTHERWISE INDICATED, PROVIDE CONDUITS OF TYPE PERMITTED OR REQUIRED, FOR ALL CONDUCTORS OR CABLES OF ALL SYSTEMS AND VOLTAGES. ALL CONDUIT SHALL BE NEW WITH UL LISTING OR LABEL AND DELIVERED TO THE SITE IN STANDARD LENGTHS. CONTRACTOR SHALL FURNISH AND INSTALL ALL CONDUIT SERVING ALL EQUIPMENT, INCLUDING BUT NOT LIMITED TO, LIGHTING, RECEPTACLES, HVAC EQUIPMENT, PLUMBING EQUIPMENT, TELEPHONE, DATA, ALARM, SPEAKERS AND ELECTRICAL EQUIPMENT. ALL CONDUIT SHALL BE CONCEALED UNLESS OTHERWISE INDICATED OR REQUIRED. RUN ALL CONDUIT PARALLEL WITH OR AT RIGHT ANGLES TO STRUCTURAL MEMBERS, WALLS OR LINES OF THE BUILDING.

A. ELECTRICAL METALLIC TUBING (EMT) - EMT SHALL BE GALVANIZED. EMT CONNECTORS SHALL BE STEEL COMPRESSION OR SET SCREW TYPE. EMT SHALL BE USED ABOVE GRADE. IN DRY LOCATIONS AND IN ACCESSIBLE CEILINGS. CONCRETE OR MASONRY IN CONTACT WITH EARTH ARE NOT CONSIDERED DRY LOCATIONS.

B. FLEXIBLE METAL CONDUIT OR MC CABLE - CABLE MUST BE THE SAME SIZE AS THE IMC OR EMT CONDUIT TO WHICH IT IS CONNECTED. BOTH THE FLEXIBLE METAL CONDUIT AND ITS FITTINGS ARE TO BE LISTED FOR GROUNDING. A GREEN GROUNDING CONDUCTOR SHALL BE INSTALLED. ALL CONDUCTORS ARE TO BE NEMA APPROVED. FLEXIBLE METAL CONDUIT SHALL BE USED FOR FINAL CONNECTIONS TO MOTORS, VIBRATING EQUIPMENT, WHERE REQUIRED FOR EQUIPMENT SERVICING, IN AND OUT OF TRANSFORMERS, INTERCONNECTION BETWEEN LIGHT FIXTURES AND HOMERUN TO PANELS WHERE CODE ALLOWS.

RIGID PLASTIC CONDUIT - RIGID PLASTIC CONDUIT SHALL BE EXTRUDED FROM VIRGIN POLYVINYL CHLORIDE COMPOUND, SCHEDULE 40 HEAVY WALL, IN 10 FOOT LENGTHS WITH COUPLINGS.

WHERE CONDUIT IS UNDERGROUND, UNDER SLAB OR GRADE, EXPOSED TO THE WEATHER OR IN WET LOCATIONS, MAKE JOINTS LIQUIDTIGHT AND GASTIGHT. END OF UNDERGROUND FEEDER CONDUITS SHALL BE SEALED AFTER THE

CABLE IS INSTALLED TO PREVENT BREATHING AND CONDENSATION. SUPPORT CONDUIT AT LEGAL INTERVALS. PROVIDE ADDITIONAL SUPPORTS AS REQUIRED TO PREVENT SAGGING OR AS DIRECTED. HANG SUPPORTS FROM STRUCTURAL MEMBERS OR APPROVED CONCRETE HANGERS.

F. DO NOT RUN CONDUIT IN CONCRETE MEMBERS OR SUSPENDED SLABS UNLESS APPROVED IN WRITING BY THE STRUCTURAL ENGINEER. CONDUITS SHALL NOT BE RUN THROUGH STRUCTURAL MEMBERS EXCEPT AS SPECIFICALLY DIRECTED IN WRITING BY THE STRUCTURAL ENGINEER. ALL CONDUITS MUST BE SIZED PER NEC AND LOCAL CODES. H. THE USE OF ROMEX, BX, ETC. IS NOT PERMITTED UNLESS APPROVED BY THE

LOCAL AUTHORITY HAVING JURISDICTION AND THE BUILDING OWNER. CONNECTIONS TO ANY OUTDOOR EQUIPMENT MUST BE WEATHER PROOF. PROVIDE PULL ROPES IN ALL EMPTY CONDUITS EXCEPT AS NOTED OTHERWISE. CONDUITS ABOVE FUTURE SUSPENDED CEILINGS SHALL BE INSTALLED AS HIGH

PROVIDE NEW CONDUCTORS AND CABLES PLAINLY MARKED AND TAGGED WITH UL LABEL, SIZE, VOLTAGE RATING, INSULATION TYPE, TYPE OF STRANDING, MANUFACTURERS NAME, TRADE NAME AND MONTH AND YEAR WHEN MANUFACTURED. CONDUCTORS SHALL BE MINIMUM #12, SOFT DRAWN, ANNEALED COPPER, MINIMUM 98% CONDUCTIVITY, 600 VOLT, TYPE THW OR THWN/THHN. A. POWER CONDUCTORS #10 AND SMALLER SHALL BE SOLID. #8 AND LARGER SHALL BE STRANDED.

MINIMUM WIRE SIZE FOR 20 AMP BRANCH CIRCUITS SHALL BE AWG LISTED, SIZE PER DISTANCE SHOWN BELOW. DISTANCE SHALL BE MEASURED FROM THE PANELBOARD CIRCUIT BREAKER TO THE FURTHEST OUTLET. a. #12 LESS THAN 100 FEET

b. #10 BETWEEN 100-150 FEFT #8 BETWEEN 150-250 FEET

. #6 OVER 250 FEET

AS POSSIBLE AGAINST THE STRUCTURE ABOVE.

ALL WIRING SHALL BE COLOR CODED AS FOLLOWS. 208/120 VOLT SYSTEM 480/277 VOLT SYSTEM NFLITRAI — WHITF NEUTRAL - GRAY PHASE A OR L1 - BLACK PHASE A OR L1 - YELLOW PHASE B OR L2 - RED PHASE B OR L2 - ORANGE

PHASE C OR L3 - BLUE PHASE C OR L3 - BROWN GROUND - GREEN GROUND - GREEN WITH YELLOW TRACER D. USE ONLY PLATED COPPER ALLOY CONNECTORS OR LUGS. ALUMINUM CONNECTORS OR LUGS ARE NOT ACCEPTABLE

ALL WIRING AND CABLE INCLUDING LOW VOLTAGE AND CONTROL CIRCUITS SHALL BE INSTALLED IN CONDUIT UNLESS OTHERWISE NOTED. THE USE OF ROMEX, BX, ETC. IS NOT PERMITTED.

G. ALUMINUM CONDUCTORS ARE NOT ACCEPTABLE.

E21- DISCONNECT SWITCHES: SAFETY AND DISCONNECT SWITCHES SHALL BE HEAVY DUTY TYPE, QUICK-MAKE, QUICK-BREAK FUSED OR NON-FUSIBLE WITH RATINGS AND SIZES AS NOTED ON THE PLANS AND REQUIRED BY CODES. PROVIDE SWITCHES WITH THE NUMBER OF POLES AND THE VOLTAGE, CURRENT AND HORSEPOWER RATINGS AS REQUIRED. PROVIDE EACH SWITCH WITH A NAMEPLATE INDICATING

A. FUSIBLE DISCONNECT SWITCHES SHALL HAVE QUICK-MAKE, QUICK-BREAK MECHANISM AND AN INTERLOCKING COVER WHICH CANNOT BE OPENED WHEN SWITCH IS IN THE "ON" POSITION AND BE PROVIDED WITH VOIDABLE INTERLOCKS. SWITCHES SHALL BE HORSEPOWER RATED AND TYPE THAT CAN BE USED ON INDUCTIVE LOADS.

NON-FUSIBLE DISCONNECT SWITCHES SHALL BE SAME TYPE AS SPECIFIED FOR FUSIBLE DISCONNECT SWITCHES, EXCEPT FOR SINGLE PHASE MOTORS 2 H.P. OR LESS, MANUAL MOTOR STARTERS MAY BE USED. DISCONNECT SWITCHES SHALL BE NEMA 3R WEATHERPROOF IN OUTDOOR

LOCATIONS OR AS REQUIRED BY LOCAL CODES. PROVIDE A FUSIBLE DISCONNECT SWITCH WITHIN SIGHT OF AND READILY ACCESSIBLE FROM AIR CONDITIONING EQUIPMENT PER NEC 440-14. SIZE

FUSES PER EQUIPMENT NAMEPLATES. PROVIDE DISCONNECT SWITCHES FOR ALL MOTORS OR EQUIPMENT OUT OF SIGHT OF THE CONTROLLER OR MORE THAN 50 FEET FROM THE CONTROLLER, PROVIDE A DISCONNECT SWITCH AT THE MOTOR OR EQUIPMENT LOCATION.

DUTLET BOXES SHALL BE ONE-PIECE GALVANIZED, SQUARE, PRESSED STEEL, KNOCKOUT TYPE, 4"x2-1/8" DEEP MINIMUM IN WALLS, AND 4'x1-1/2" DEEP MINIMUM IN CEILINGS, WITH PLASTER RINGS. CAST BOXES SHALL BE THREADED HUB CAST FERROUS, OR ALUMINUM BOXES WHERE LEGALLY PERMITTED.

A. EXTERIOR BOXES SHALL BE CAST RUST RESISTING METAL WITH GASKETED B. USE SOLID TYPE GANG BOXES WHERE REQUIRED FOR MORE THAN TWO

DEVICES OR FOR BARRIERED OUTLETS. USE CONCRETE BOXES FOR OUTLETS IN CONCRETE CONSTRUCTION. INSTALL BOXES RIGIDLY FROM BUILDING STRUCTURE AND SUPPORT INDEPENDENTLY OF THE CONDUIT SYSTEM. SUPPORT RECESSED BOXES IN

SPECIFICALLY FOR THE PURPOSE ALL BOXES SHALL BE OF PROPER CODE SIZE FOR NUMBER AND SIZES OF CONDUCTORS PASSING THROUGH OR TERMINATING THEREIN.

STUD PARTITIONS WITH GALVANIZED STEEL BOX HANGERS OF TYPES MADE

E. BEFORE ROUGHING IN BOXES FOR SWITCHES AT DOOR, CONTRACTOR SHALL VERIFY DOOR SWING TO MAKE SURE THAT SWITCH IS ON THE STRIKE SIDE OF

E23 – JUNCTION AND PULL BOXES:

THE PLANS INDICATE ONLY SCHEMATIC ROUTINGS FOR CONDUIT RUNS. THIS CONTRACTOR SHALL FURNISH AND INSTALL ADDITIONAL BOXES WHERE REQUIRED BY FIELD CONDITIONS OR BY CODE. A. BOXES AND COVERS SHALL BE GALVANIZED STEEL OF CODE GAUGE SIZE. B. IN WET LOCATIONS. OUTDOORS OR WHERE INDICATED TO BE WEATHERPROOF PROVIDE BOXES THAT HAVE BEEN HOT-DIPPED GALVANIZED AFTER

CONSTRUCTION AND GIVEN TWO COATS OF GRAY COLOR RUST-RESISTING

PAINT. INSTALL COVERS WITH STAINLESS STEEL SCREWS AND NEOPRENE GASKETS. SEAL AROUND CONDUIT ENTRIES WITH SILICONE SEALANT INSTALL BOXES RIGIDLY FROM BUILDING STRUCTURE AND SUPPORT INDEPENDENTLY OF THE CONDUIT SYSTEM. WHERE INDICATED OR REQUIRED TO SERVE AS PULL BOXES OR JUNCTION

BOXES, PROVIDE SHEET STEEL BOXES WITH SCREW ON COVERS FOR SURFACE OR FLUSH MOUNTING. ARRANGE CIRCUITS TO AVOID THE USE OF JUNCTION BOXES IN INACCESSIBLE LOCATIONS. THE USE OF JUNCTION BOXES ABOVE DRYWALL CEILINGS SHOULD BE LIMITED TO LOCATIONS NEAR ACCESS FRAMES USED FOR DIFFUSERS AND RETURN AIR GRILLES OR ACCESS PANELS AS LOCATED ON

JUNCTION AND PULL BOXES MUST BE LABELED WITH CIRCUIT NUMBERS IDENTIFIED AND SYSTEM TYPE ON BOXES COVER.

HANGERS SHALL INCLUDE ALL MISCELLANEOUS STEEL SUCH AS ANGLE IRON, BANDS, C-CLAMPS, CHANNELS, HANGER RODS, ETC., NECESSARY FOR THE INSTALLATION. HANGERS SHALL BE FASTENED TO BUILDING STEEL, CONCRETE OR MASONRY, BUT NOT PIPING OR DUCTWORK. HANGING FROM METAL DECK IS NOT PERMITTED. WHERE INTERFERENCE'S OCCUR, AND IN ORDER TO SUPPORT DUCTWORK OR PIPING. THE CONTRACTOR MUST INSTALL TRAPEZE TYPE HANGERS OF SUPPORTS WHICH SHALL BE LOCATED WHERE THEY DO NOT INTERFERE WITH ACCESS TO FIRE DAMPERS, VALVES, AND OTHER EQUIPMENT. HANGER TYPES AND INSTALLATION METHODS ARE ALSO SUBJECT TO LOCAL CODES AND LANDLORD REQUIREMENTS. HANGERS AND PIPING OF DISSIMILAR METALS SHALL BE DIELECTRIC ALLY SEPARATED.

E25- SUPPORTS:

PROVIDE ALL NECESSARY FOUNDATIONS, SUPPORTS AND BACKING FOR ALL ENCLOSURES, CONDUITS EQUIPMENT, OUTLETS, DEVICES AND LIGHTING FIXTURES. ATTACH ALL BOXES, OUTLET BOXES, STRAPS, CABINETS AND EQUIPMENT TO WOOD WITH WOOD OR LAG SCREWS, TO METAL WITH MACHINE SCREWS OR BOLTS. AND TO CONCRETE WITH EXPANSION ANCHORS OR SELF DRILLING METAL ANCHORS, AND WITH MACHINE SCREWS OR BOLTS. USE SIZE AND NUMBER OF ATTACHMENTS AS REQUIRED TO SUPPORT FOUIPMENT WEIGHT WITH A MINIMUM SAFETY FACTOR OF 4 TO 1. SECURE FLOOR MOUNTED EQUIPMENT TO FLOOR WITH MACHINE BOLTS AND ANCHORS.

E26- HVAC, PLUMBING & FIRE PROTECTION: ELECTRICAL CONTRACTOR SHALL BE RESPONSIBLE FOR ALL POWER WIRING, LINE VOLTAGE WIRING, AND LINE VOLTAGE CONTROL WIRING WHERE INDICATED UNDER THE HEATING, VENTILATION, AIR CONDITIONING, PLUMBING, AND FIRE PROTECTION SPECIFICATIONS AND DRAWINGS. THIS CONTRACTOR SHALL ALSO INTERCONNECT LINE VOLTAGE WIRING BETWEEN RELAYS AND SWITCHES AS REQUIRED.

E27 WIRING DEVICES: THIS CONTRACTOR SHALL FURNISH AND INSTALL SWITCHES AND RECEPTACLES. UNLESS NOTED OTHERWISE, AS NECESSARY FOR A COMPLETE INSTALLATION. COLOR OF DEVICES AND PLATES SHALL MATCH WALL COLOR OR AS REQUIRED BY ARCHITECT. THE DEVICES SHALL BE OF THE TYPES AND RATINGS LISTED, OR APPROVED FOUALS.

PASS & SEYMOUR SINGLE POLE SWITCH TWO POLE SWITCH HBL-1222 5522-1 HBL-1223 THREE WAY SWITCH 5523 - 1DUPLEX RECEPTACLE 5362 5262-1 1404 GFI RECEPTACLE GF5352 6198-1 1591-F

E28- TOGGLE SWITCHES: ALL SWITCHES SHALL BE SPECIFICATION GRADE RATED 15, 20 OR 30 AMPERES AT 277 VOLT AC, TOTALLY ENCLOSED QUIET ACTION TYPE, 1 OR 2 POLE, 3 OR 4 WAY, MOMENTARY CONTACT OR LOCK TYPE AS REQUIRED. THE 15 AMPERE RATED SWITCH MAY BE USED ONLY FOR LIGHTING LOADS OF LESS THAN 10 AMPERES. SWITCHES AHEAD OF MOTORS SHALL BE HORSEPOWER RATED AND SHALL HAVE NUMBER OF POLES AS REQUIRED. TOGGLE COLORS SHALL BE AS SELECTED BY THE ARCHITECT. FOR FLUSH MOUNTED WEATHERPROOF SWITCHES, PROVIDE GASKETED STAINLESS STEEL LIFT COVER PLATE, PASS & SEYMOUR WP SERIES. WHERE SURFACE MOUNTED, USE CAST BOX WITH GASKETED CAST ALUMINUM LIFT COVER PLATE, HUBBELL #7420, WHERE APPLICABLE.

E29- MOTOR STARTERS: MAGNETIC MOTOR STARTERS SHALL BE PROVIDED WITH RESET TYPE OVERLOADS THAT CLOSELY MATCH MOTOR NAMEPLATE RATING AND SHALL BE ELECTRICALLY HELD (MINIMUM SIZE #1 IN A NEMA 1 ENCLOSURE) AND BE USED FOR ALL SINGLE PHASE AND THREE PHASE MOTORS RATED ABOVE 1/2 H.P. THAT REQUIRE AUXILIARY CONTROL. PROVIDE CONTROL DEVICES (AUXILIARY CONTACTS, TRANSFORMERS, H-O-A, ETC.) IN STARTERS AS REQUIRED FOR INTERLOCKS. COORDINATE ALL CONTROL DEVICES WITH MECHANICAL CONTRACTOR. COMBINATION STARTER/DISCONNECT SWITCHES SHALL CONTAIN FUSIBLE SWITCHES AND ONLY USED WHERE INDICATED ON DRAWINGS.

E30- LIGHTING FIXTURES AND LAMPS: THIS CONTRACTOR SHALL PROVIDE, INSTALL, AND CONNECT ALL LIGHTING FIXTURES AND LAMPS INDICATED ON THE DRAWINGS ACCORDING TO THE FIXTURE SCHEDULE. ALL FIXTURES SHALL BE U.L. LABELED. CONTRACTOR IS TO REPLACE ALL NON-WORKING LAMPS PRIOR TO CERTIFICATE OF

OCCUPANCY DATE AND SHALL INCLUDE COST IN HIS BID. A. FLUORESCENT BALLASTS SHALL BE ELECTRONIC PREMIUM TYPE C.B.M. CERTIFIED, E.T.L. APPROVED, U.L. LISTED, HIGH POWER FACTOR, RAPID

START AND OF THE VOLTAGE REQUIRED. B. HID BALLASTS SHALL BE U.L. LISTED FOR THE SOURCE, WATTAGE AND POSITION OF THE LAMP PROVIDED.

C. DIMMABLE BALLASTS SHALL BE SUPPLIED FOR DIMMABLE FLUORESCENT FIXTURES AND SHALL BE ADVANCE OR EQUAL. D. ALL RECESSED INCANDESCENT FIXTURES SHALL BE PROVIDED WITH APPLICABLE

THERMAL PROTECTION. . LIGHT FIXTURES INSTALLED OUTDOORS IN LOCATIONS PROTECTED FROM THE WEATHER (AS UNDER CANOPIES) SHALL BE RATED FOR OUTDOOR USE.

GASKETED AND FINISHED WITH AN APPROVED CORROSION RESISTANT FINISH CONTRACTOR SHALL FURNISH ADDITIONAL SUPPORT STEEL HANGER WIRES ADEQUATELY SIZED TO SUPPORT THE WEIGHT OF THE FIXTURE FASTENED TO THE BUILDING STRUCTURE FOR ALL FIXTURES IN LAY-IN CEILINGS AND OTHER

FIXTURES AS REQUIRED BY THE LOCAL CODE OFFICIAL. G. FURNISH AND INSTALL APPLICABLE FIRE RATED DRYWALL BOXES OVER RECESSED FIXTURES IN FIRE RATED CEILINGS AS REQUIRED BY CODE.

FURNISH AND INSTALL A COMPLETE WIRED GROUNDING CONDUCTOR SYSTEM, #12 AWG MINIMUM, SIZED AND INSTALLED IN ACCORDANCE WITH THE LATEST ADOPTED EDITION OF THE NATIONAL ELECTRICAL CODE, STATE CODES, LOCAL CODES AND AS NOTED IN THE SPECIFICATION AND INDICATED ON THE DRAWINGS.

A. FOR THE SYSTEM GROUND CONNECTION, PROVIDE A GREEN COLOR INSULATED COPPER CONDUCTOR IN A RIGID STEEL CONDUIT TO THE GROUND ELECTRODE. CONNECT THE CONDUIT AND CONDUCTOR TO THE ELECTRODE WITH A MALLEABLE IRON CONDUIT HUB AND A 2-BOLT GROUND CLAMP. B. GROUNDING CONNECTIONS MADE TO THE WATER PIPING SYSTEM SHALL BE

COORDINATED WITH THE PLUMBING CONTRACTOR AND A BONDING JUMPER INSTALLED AROUND THE WATER METER PER CODES AND AS INDICATED ON DRAWINGS. WHERE THE COLD WATER PIPING SYSTEM IS UNSUITABLE FOR USE AS A GROUNDING ELECTRODE AND WHERE LOCAL CODE PERMITS, PROVIDE COPPER-CLAD MULTIPLE-ROD ELECTRODES COMPLYING WITH ALL LEGAL REQUIREMENTS INCLUDING ROD SIZE, SPACING ACCESSIBILITY AND RESISTANCE TO GROUND.

C. GROUND THE NEUTRAL OF EACH ISOLATED ELECTRICAL SYSTEM HAVING A NEUTRAL CONDUCTOR WITH A SYSTEM GROUND CONNECTION SIZED AS

D. ALL CONDUIT INCLUDING FLEXIBLE CONDUIT AND NON-METALIC CONDUITS SHALL BE GROUNDED WITH A GREEN GROUNDING CONDUCTOR. E. A SEPARATE ISOLATED GROUNDING CONDUCTOR, #12 AWG MINIMUM, IN EACH CONDUIT FEEDING THE CASH WRAP AND OTHER COMPUTERIZED EQUIPMENT

SHALL BE ROUTED. F. ALL DEVICES SHALL BE BONDED TO THE CONDUCTOR SYSTEM. USE A BONDING JUMPER BETWEEN THE OUTLET BOX AND THE DEVICE GROUNDING TERMINAL. ALL JUNCTION BOXES, OUTLET BOXES AND PULL BOXES SHALL BE BONDED TO THE CONDUIT SYSTEM.

G. ALL ENCLOSURES AND NON-CURRENT CARRYING METAL PARTS ARE TO BE GROUNDED. CONDUIT SYSTEM IS TO BE ELECTRICALLY CONTINUOUS WHERE ENCLOSURES AND NON-CURRENT CARRYING METAL PARTS ARE ISOLATED FORM THE CONDUIT SYSTEM, USE BONDING JUMPERS WITH APPROVED CLAMPS.

ALL WIRING AND CONNECTIONS SHALL BE TESTED FOR CONTINUITY, SHORTS AND IMPROPER GROUNDS IN ACCORDANCE WITH THE REQUIREMENTS OF THE NATIONAL ELECTRICAL CODE. ALL RECEPTACLE OUTLETS SHALL SHALL BE TESTED FOR PROPER GROUNDING. ANY AND ALL REPAIRS RESULTING FROM THE TESTS OR PRELIMINARY OPERATION OF THE EQUIPMENT SHALL BE MADE BY THE CONTRACTOR AT HIS EXPENSE. A. REQUIRED TESTS IN ADDITION TO THOSE MENTIONED ABOVE INCLUDE BUT ARE

NOT LIMITED TO: GROUND RESISTANCE TEST. SERVICE AND FEEDER CONDUCTORS INSULATION RESISTANCE. GROUND FAULT PROTECTION.

SUCH OTHER TESTS AS MAY BE REQUIRED BY THE ARCHITECT. MAKE CORRECTIONS/ADJUSTMENTS FOR PHASE BALANCING. B. CONTRACTOR IS TO BALANCE THE VOLTAGE LEAVING THE STEP-DOWN TRANSFORMER TO PROVIDE A SECONDARY VOLTAGE OF 120 MINIMUM TO 125 VOLTS MAXIMUM BY ADJUSTING THE TRANSFORMER TAPS ONCE ALL THE FINAL

CONNECTIONS HAVE BEEN MADE TO THE LOW VOLTAGE PANELBOARD. C. CONDUCT ALL OTHER AND/OR ADDITIONAL TESTS THAT ARE REQUIRED BY THE AUTHORITY HAVING JURISDICTION OR ARE REQUESTED BY THE ARCHITECT. ALL COSTS INCURRED INCLUDING REQUIRED INSTRUMENTS AND PERSONAL FOR THE TESTS SHALL BE PAID FOR BY THE CONTRACTOR.

UPON COMPLETION OF THE WORK UNDER THIS SECTION. THE CONTRACTOR SHALL REMOVE ALL SURPLUS MATERIALS, EQUIPMENT AND DEBRIS INCIDENTAL TO THIS WORK AND LEAVE THE PREMISES CLEAN AND ORDERLY. THE CONTRACTOR SHALL CLEAN ALL EQUIPMENT, INCLUDING LIGHT FIXTURES, TO THE SATISFACTION OF THE ARCHITECT. ALL DUST, DIRT, DEBRIS AND FOREIGN MATTER SHALL BE REMOVED FROM ALL EQUIPMENT.

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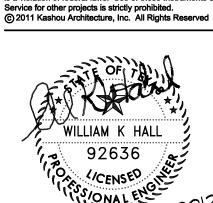
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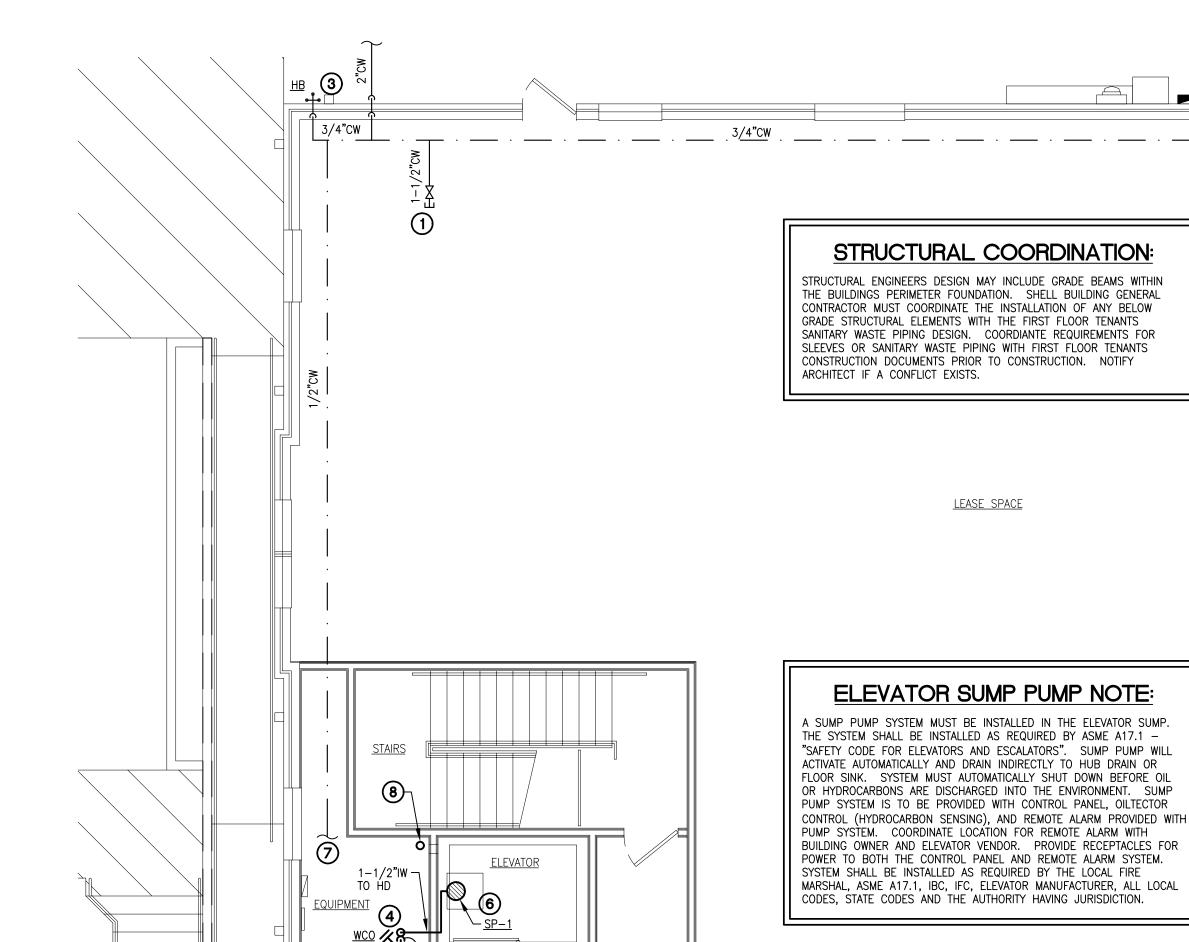
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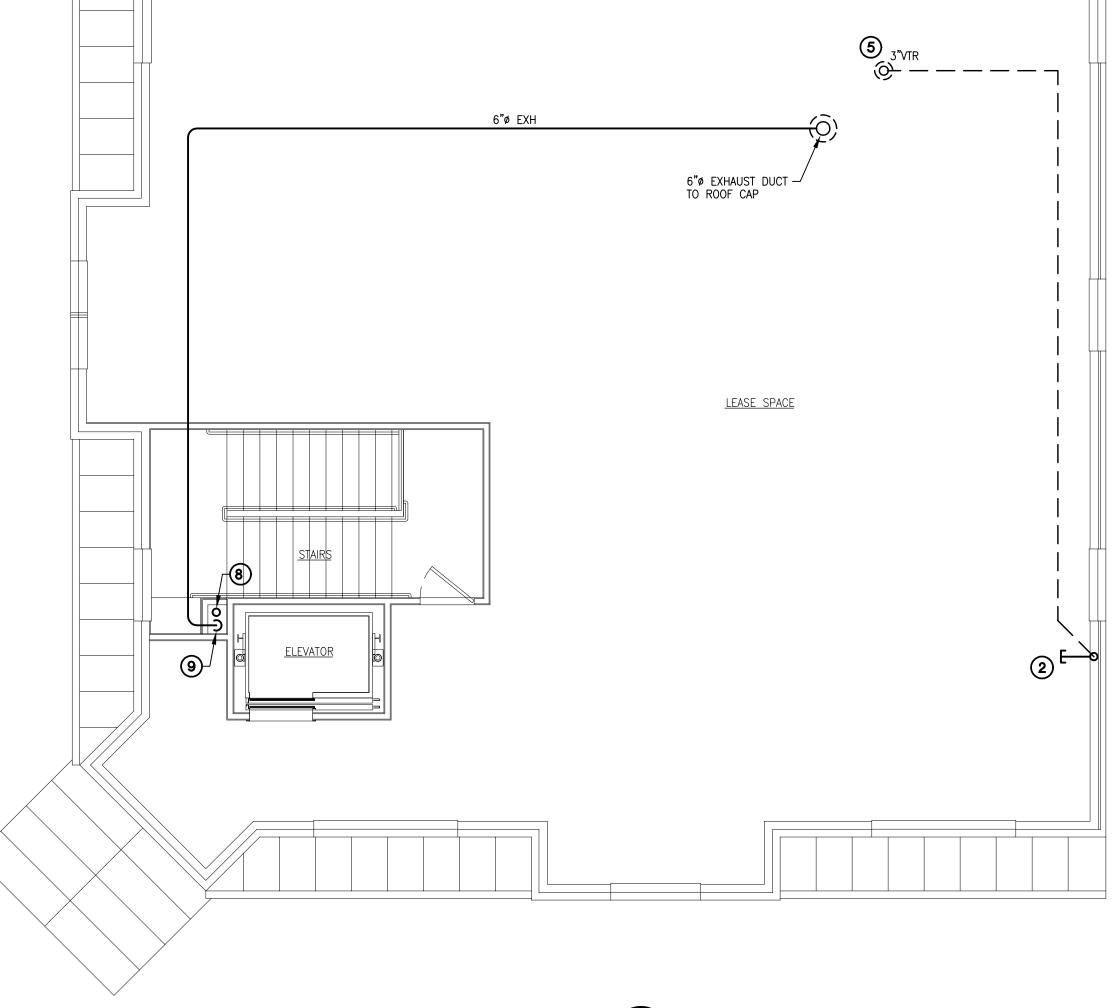
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SPECIFICATIONS |

**ELECTRICAL** 



<u>LOBBY</u>



PLUMBING PLAN - SECOND FLOOR

3/16" = 1'-0"

	PLUMBING FIXTURE SCHEDULE									
MARK	DESCRIPTION	MANUFACTURER	MODEL	COLD WATER	HOT WATER	WASTE	VENT	NAT GAS	NOTES	
<u>FD</u>	FLOOR DRAIN - WITH TRAP PRIMER	ZURN	ZN-415-B-P-Y			3"	2"		4	
<u>HB</u>	HOSE BIBB — NON FREEZE WALL HYDRANT WITH VACUUM BREAKER, DOOR AND KEY	WOODFORD	B-65	3/4"					2	
IP	TRAP PRIMER	PRECISION PLUMBING PRODUCTS	P-2	1/2"					3	
WHA	WATER HAMMER ARRESTOR	PRECISION PLUMBING PRODUCTS	SIZE 'A'	3/4"					1	
<u>SP-1</u>	SUMP PUMP	LIBERTY	ELV280			1-1/2"				

NOTES:

TO BE SIZED PER IPC.
 PROVIDE HOSE BIBB WITH VACUUM BREAKER.

PROVIDE HOSE BIBB WITH VACUUM BREAKER.
 STANDARD INSTALLATION WITH ACCESS PANEL.
 PROVIDE WITH VACUUM BREAKER.

3/16" = 1'-0"

### PLUMBING GENERAL NOTES:

- CONTRACTOR IS RESPONSIBLE FOR FIELD VERIFICATION OF ALL CONDITIONS AND IS RESPONSIBLE FOR REPORTING ANY CONFLICTS TO THE ARCHITECT PRIOR TO THE START OF WORK.
- 2. "EXISTING" OR "VERIFY IN FIELD" MEANS THE CONTRACTOR IS TO CONFIRM THE ITEM SHOWN ON THE DRAWING EXISTS AND IS IN GOOD WORKING CONDITION. SHOULD THE CONTRACTOR FIND THE EQUIPMENT IS NOT AS SHOWN ON THESE DRAWINGS, IT IS TO BE INSTALLED AS REQUIRED TO PROVIDE THE TENANT WITH A FULLY FUNCTIONING SYSTEM AND AS REQUIRED BY ALL LOCAL CODES AND THE LOCAL AUTHORITY HAVING JURISDICTION.
- CONFIRM THE EXACT LOCATION OF SEWER LINE AND CONFIRM ADEQUATE INVERT ELEVATION
  IS AVAILABLE FOR 1/4" PER FOOT SLOPE OF PLUMBING LINES SHOWN. SANITARY PIPING
  TO BE SLOPED AT A MINIMUM OF 1/4" PER FOOT UNLESS NOTED OTHERWISE.
- 4. ANY PENETRATION THRU OR TRENCHED IN CONCRETE FLOORS OR PARTITIONS SHALL BE SAW CUT OR CORE DRILLED.
- 5. ANY PENETRATIONS THRU FIRE RATED PARTITIONS SHALL BE SEALED AS REQUIRED TO UPHOLD THE RATING OF THE PARTITION.
- 6. THE PLUMBING CONTRACTOR SHALL NOT INSTALL EXPOSED PIPING ABOVE OR WITHIN THE CODE REQUIRED WORKING CLEARANCES OF ANY ELECTRICAL PANELBOARD OR SWITCHGEAR. COORDINATE WITH ELECTRICAL CONTRACTOR.
- 7. PLUMBING CONTRACTOR SHALL MAKE ALL FINAL CONNECTIONS TO OWNER SUPPLIED EQUIPMENT REQUIRING PLUMBING CONNECTIONS.
- 8. ALL TAP FEES, IMPACT FEES AND PUBLIC ASSESSMENT FEES ARE TO BE INCLUDED IN THIS CONTRACTORS PRICE.
- 9. CONTRACTOR IS REQUIRED TO CONTACT THE BUILDING LANDLORD FOR ANY ROOF WORK. IF LANDLORD REQUIRES A SPECIFIC ROOFING CONTRACTOR, IT IS THE RESPONSIBILITY OF THE CONTRACTOR TO CONTACT, COORDINATE AND PAY FOR ANY AND ALL ROOFING WORK WITH THE LANDLORDS ROOFING CONTRACTOR.
- 10. PROVIDE CLEAN-OUTS AT THE ENDS OF RUNS.
- 11. MAINTAIN MINIMUM OF 10'-0" HORIZONTAL DISTANCE BETWEEN PLUMBING ROOF JACKS (VENTS) AND FRESH AIR INTAKES OR OUTSIDE AIR INTAKES.
- 12. PROVIDE ISOLATION VALVES AT ALL FIXTURES.

PLUMBING PLAN - FIRST FLOOR

1 1-1/2" DOMESTIC WATER WITH VALVE AND CAPPED FOR FUTURE CONNECTION BY TENANT.

PLUMBING KEYED NOTES:

- PROVIDE 4" SANITARY STUB FOR FUTURE TENANT CONNECTION. TEMPORARILY CAP PIPING 36"AFF. COORDINATE LOCATIONS WITH OWNERS FUTURE DEMISING PLANS PRIOR TO CONSTRUCTION.
- (3) HOSE BIBB WITH VACUUM BREAKER. VERIFY LOCATION AND TYPE WITH BUILDING OWNER.
- 3" HUB DRAIN TO RECEIVE INDIRECT WASTE FROM ELEVATOR PIT SUMP PUMP AS REQUIRED BY ASME A17.1. COORDINATE HUB DRAIN LOCATION WITH ELEVATOR EQUIPMENT PLAN AND ELEVATOR EQUIPMENT VENDOR PRIOR TO CONSTRUCTION. SUBSTITUTE FLOOR SINK FOR HUB DRAIN WHERE REQUIRED. INSTALL TRAP PRIMER AND ROUTE FILL LINE TO
- COORDINATE VENT THRU ROOF LOCATION WITH ROOFER AND ARCHITECT. VENT SHALL BE LOCATED ON BACK SIDE OF ROOF AND NOT IN LINE OF SIGHT FROM FIRST STREET OR SYMS STREET.
- ELEVATOR PIT SUMP PUMP INSTALLED AS REQUIRED BY ELEVATOR MANUFACTURER, ASME A17.1, AND LOCAL AHJ. SUMP PUMP TO BE SUPPLIED WITH OIL AND HYDROCARBON SENSING SYSTEM "LIBERTY ELV" SUMP PUMP SYSTEM WITH "OILTECTOR" CONTROL. HYDROCARBONS MUST NOT BE DISCHARGED INTO THE ENVIRONMENT. REFER TO DETAIL 4/P-4 FOR SUMP PUMP SYSTEM SPECIFICATION AND ADDITIONAL INFORMATION.
- 7) 1/2"CW TO TRAP PRIMER FOR HUB DRAIN.
- 8 ROUTE VENT LINE UP THRU CHASE. REFER TO NOTE #5 FOR VENT TERMINATION LOCATION AND REQUIREMENTS.
- ROUTE 6"Ø EXHAUST DUCT UP THRU CHASE. DUCT ROOF PENETRATION TO BE AT REAR OF BUILDING SIMILAR TO PLUMBING VENT.

Dental Clinic Shell Building 8502 Syms Street, Fulshear TX 7744

# Kashou

architecture


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PLUMBING PLANS

Dwg. No.

Dwg. Name

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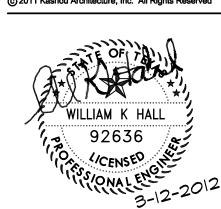
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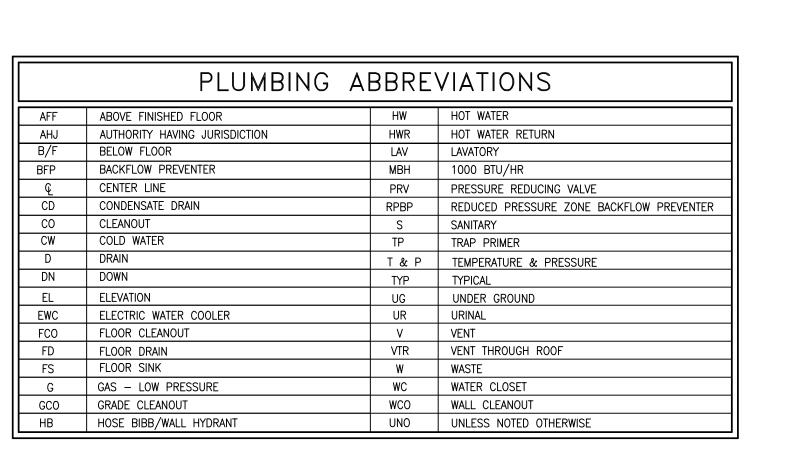
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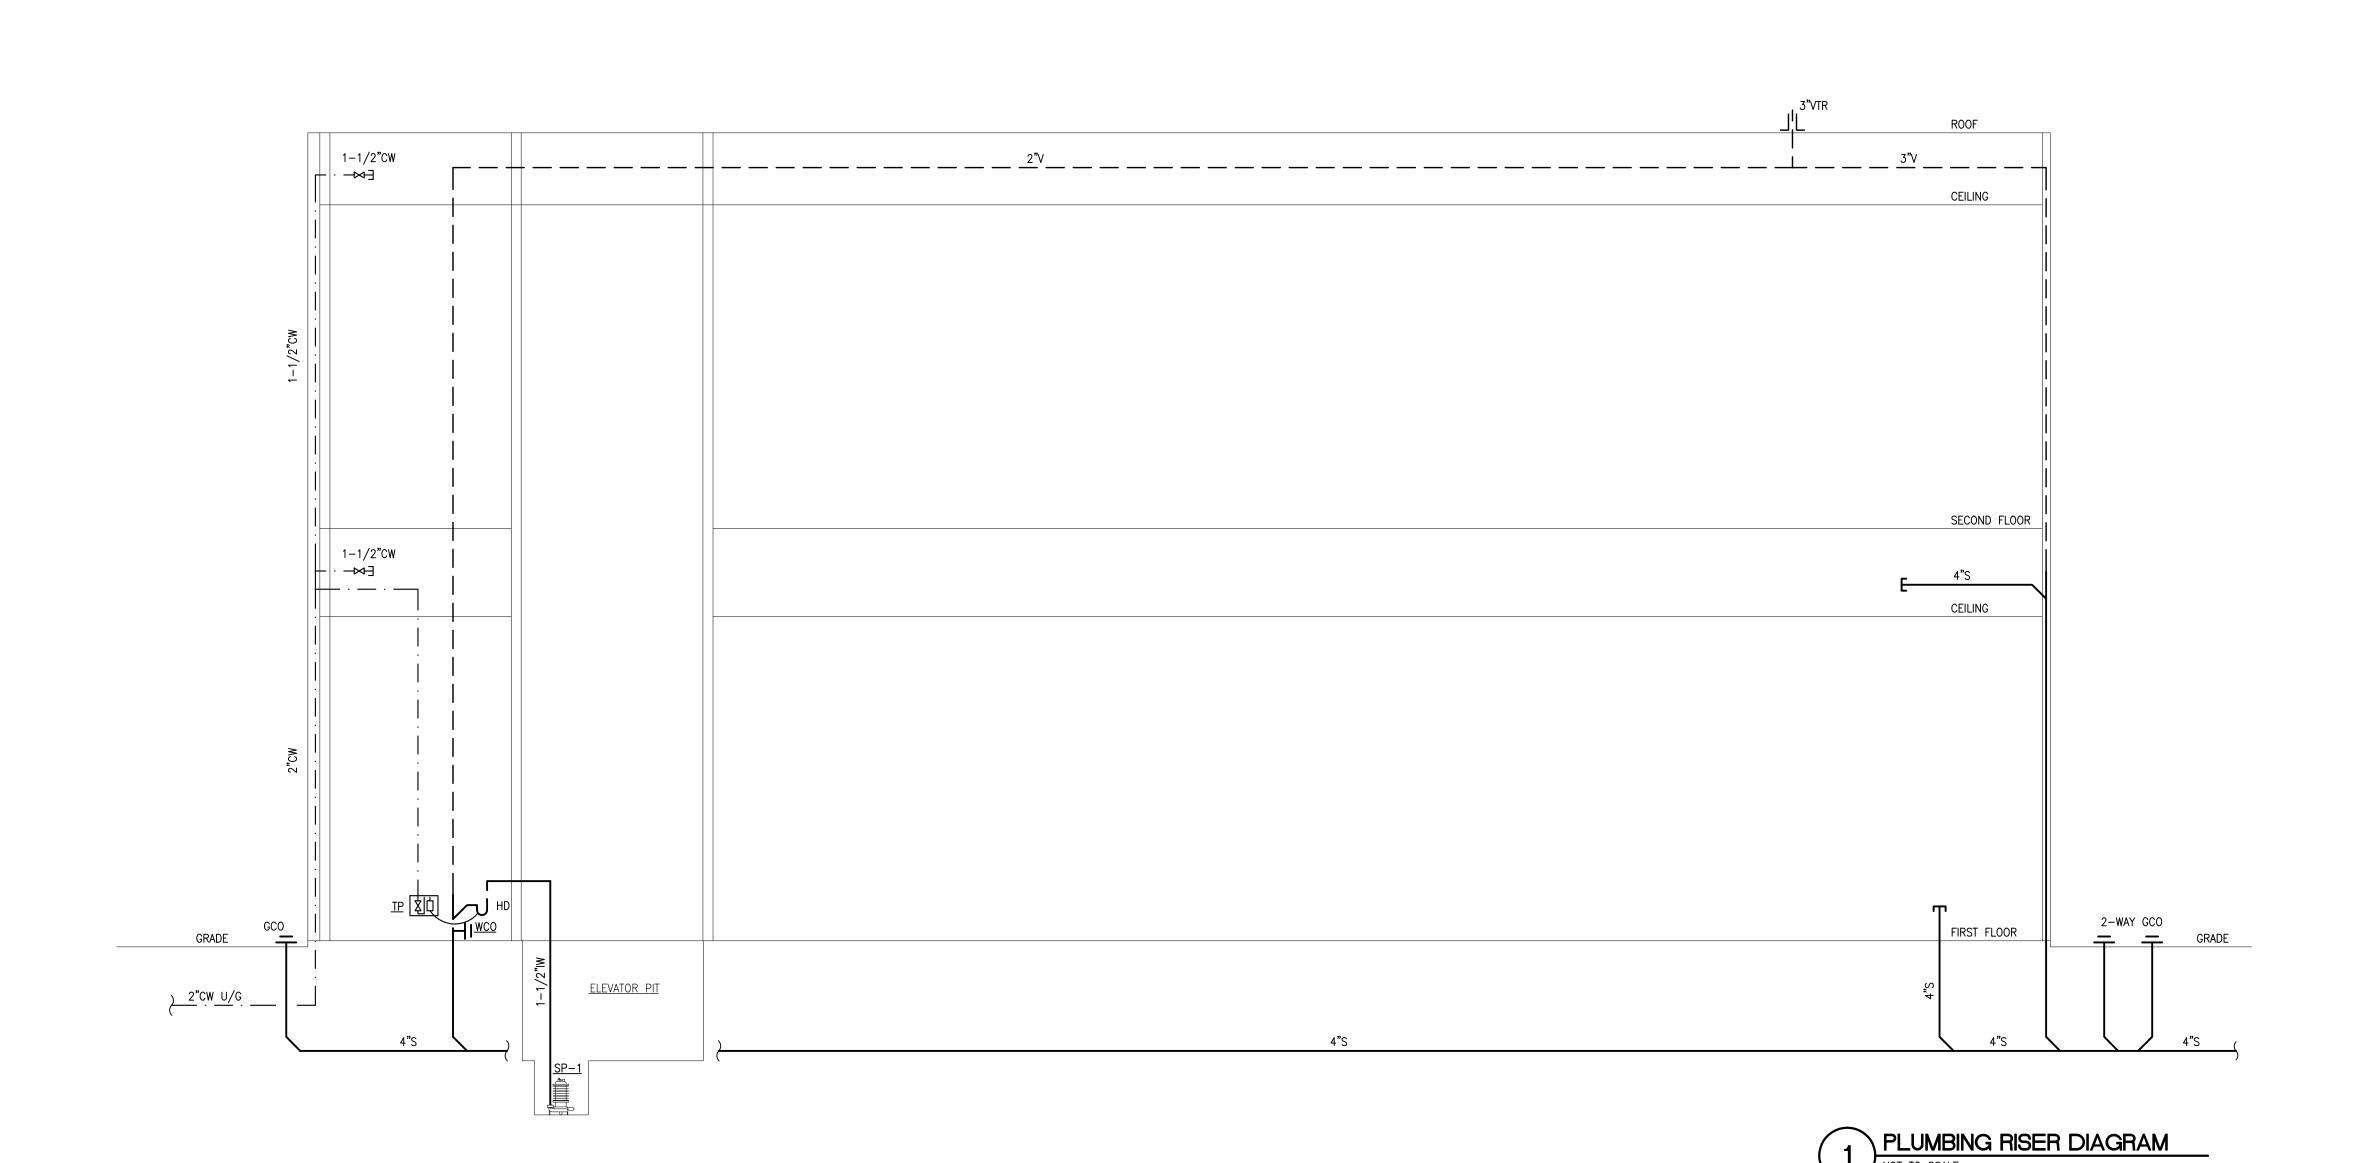


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**PLUMBING** RISER

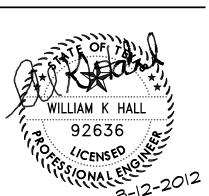Dwg. No.





PLUMBING SYMBOLS LEGEND

DOMESTIC COLD WATER PIPING DOMESTIC HOT WATER PIPING

SANITARY SEWER

GREASE WASTE VENT PIPING

NATURAL GAS PIPING

POINT OF CONNECTION

FLOOR CLEANOUT

WALL CLEANOUT

UNION

GAS COCK

CHECK VALVE

RISE IN PIPING

DROP IN PIPING

HOSE BIBB


CLEANOUT TO GRADE

BACKFLOW PREVENTER


# GRADE/SURFACE CLEANOUT DETAIL

BE VERIFIED WITH ARCHITECT PRIOR TO


INSTALLATION.

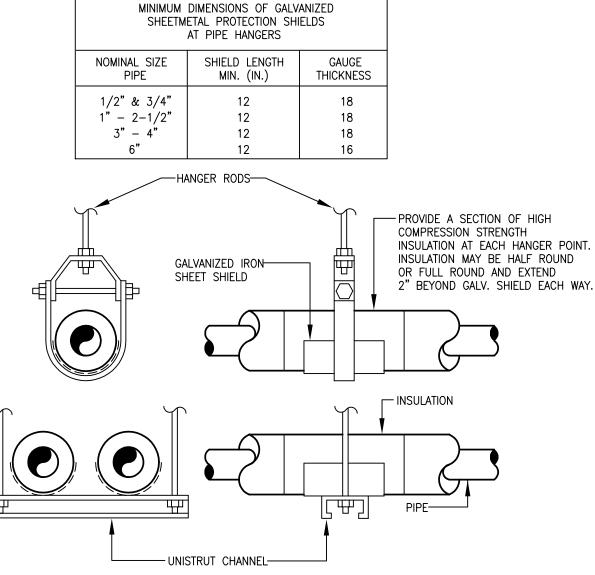



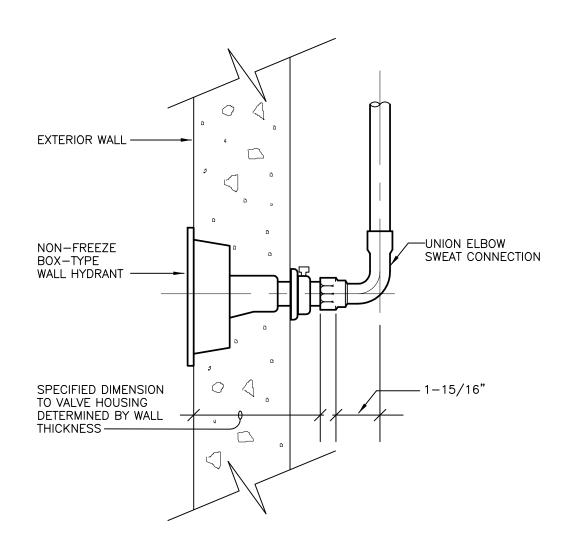

# NON FREEZE WALL HYDRANT

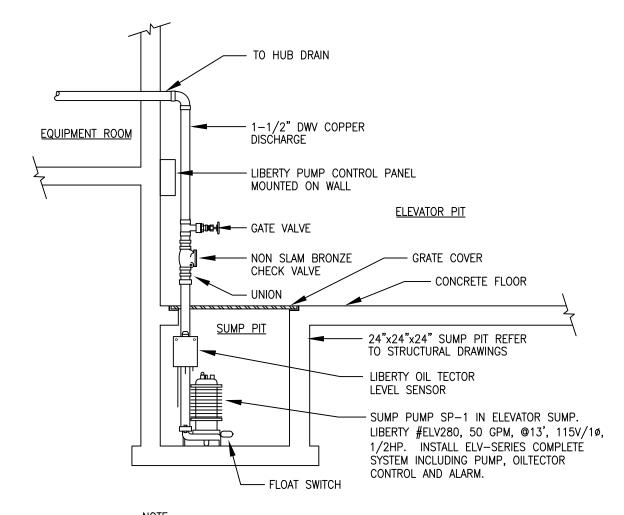

SUMP PUMP LOCATION AND REQUIREMENTS MUST BE COORDINATED WITH ELEVATOR SYSTEM VENDOR AND EQUIPMENT PRIOR TO CONSTRUCTION. SYSTEM SHALL BE INSTALLED AS REQUIRED BY AND COMPLY WITH ALL TEXAS STATE REQUIREMENTS.



### PLUMBING SPECIFICATIONS

### SECTION 15400 BASIC PLUMBING REQUIREMENTS

- A. THE CONTRACTOR SHALL PROVIDE ALL LABOR, MATERIALS, EQUIPMENT AND SERVICES REQUIRED TO COMPLETE THE INSTALLATION OF THE WORK OF THIS SECTION AS SHOWN ON THE DRAWINGS AND DESCRIBED HEREIN, INCLUDING ALL INCIDENTAL WORK NECESSARY TO MAKE IT COMPLETE, SATISFACTORY AND READY FOR OPERATION AND USE. MAKE READY FOR OWNER'S USE COMPLETE PLUMBING SYSTEMS TO THE SATISFACTION OF THE OWNER, ARCHITECT AND MECHANICAL ENGINEER.
- B. THE CONTRACTOR SHALL FURNISH AND INSTALL ALL WORK NECESSARY TO MAKE A COMPLETE SYSTEM WHETHER OR NOT SUCH DETAILS ARE MENTIONED IN THESE SPECIFICATIONS AS SHOWN ON THE PLANS, BUT WHICH ARE OBVIOUSLY NECESSARY TO MAKE A COMPLETE SYSTEM, EXCEPTING ONLY THOSE PORTIONS THAT ARE SPECIFICALLY MENTIONED HEREIN OR PLAINLY MARKED ON THE ACCOMPANYING DRAWINGS AS BEING INSTALLED UNDER
- ANOTHER SECTION OF THE SPECIFICATIONS. C. BEFORE STARTING ANY WORK. THE CONTRACTOR FOR THIS SECTION OF THE WORK SHALL EXAMINE A COMPLETE SET OF DRAWINGS AND SPECIFICATIONS FOR ALL TRADES, INCLUDING ARCHITECTURAL, STRUCTURAL, HVAC, ELECTRICAL, FIRE PROTECTION, AND PLUMBING. DIMENSIONS, SPACE REQUIREMENTS, AND POINTS OF CONNECTION TO ALL EQUIPMENT SHALL BE VERIFIED, AND ANY MINOR ADJUSTMENTS NECESSARY TO AVOID CONFLICT WITH THE BUILDING STRUCTURE AND THE WORK OF THE OTHER TRADES SHALL BE MADE. CONTRACTOR SHALL NOTIFY ARCHITECT IMMEDIATELY IF ANY MAJOR CONFLICTS OCCUR.

<u>P2 – WORKMANSHIP:</u>

ALL WORK SHALL BE PERFORMED BY COMPETENT MECHANICS USING PROPER TOOLS AND EQUIPMENT TO PRODUCE FIRST-QUALITY WORK. ALL WORK SHALL BE NEATLY INSTALLED, ACCESSIBLE FOR MAINTENANCE, COMPLETE WITH ALL ACCESSORIES REQUIRED, AND MEETING THE APPROVAL OF THE OWNER AND THE ARCHITECT.

ALL PRODUCTS, EQUIPMENT, MATERIALS, AND ACCESSORIES SHALL BE OF FIRST-LINE QUALITY, GRADE AND TYPE SHOWN ON THE DRAWINGS AND SPECIFIED, OR EQUIVALENTS ACCEPTED BY THE ARCHITECT OR ENGINEER IN WRITING.

<u>P4 – SITE INSPECTION:</u>

CONTRACTOR SHALL VISIT THE JOB SITE PRIOR TO SUBMITTING HIS BID AND THOROUGHLY FAMILIARIZE HIMSELF WITH ALL EXISTING CONDITIONS AND EXACT NATURE OF THE WORK, THE DRAWINGS ARE ESSENTIALLY DIAGRAMMATIC. SUBMISSION OF A BID ACKNOWLEDGES FULL RESPONSIBILITY FOR FURNISHING A COMPLETE AND FUNCTIONAL SYSTEM. NO CHANGES IN CONTRACT WILL BE MADE TO ACCOMMODATE OR ALLOW EXTRA FUNDS FOR ANY OMISSION WHICH RESULTS FROM A FAILURE TO THOROUGHLY MAKE THE EXAMINATION.

THE ENTIRE INSTALLATION SHALL CONFORM TO THE REQUIREMENTS OF THE LATEST APPLICABLE EDITION OF THE CODES, ORDINANCES AND REGULATIONS INTERPRETED BY THE LOCAL AUTHORITY HAVING JURISDICTION.

THE CONTRACTOR SHALL OBTAIN AND PAY FOR ALL PERMITS, INSPECTIONS AND FEES. COPIES OF ALL PERMITS AND INSPECTION REPORTS SHALL BE SUBMITTED TO THE ARCHITECT.

<u>P7 – AS-BUILTS:</u>

CONTRACTOR SHALL PROVIDE A COMPLETE SET OF AS-BUILTS TRANSPARENCIES WITH ALL CHANGES NOTED THEREON AT THE COMPLETION OF THE PROJECT AND PRIOR TO FINAL ACCEPTANCE AND PAYMENT. THESE DRAWINGS SHALL HAVE ALL INSTALLATIONS REFERENCED BY DIMENSIONS TO A SET REFERENCE POINT OR POINTS.

P8 – GUARANTEE:

CONTRACTOR SHALL UNCONDITIONALLY GUARANTEE ALL LABOR AND MATERIALS ON ALL WORK AGAINST DEFECTS IN WORKMANSHIP AND MATERIALS FOR A PERIOD OF ONE YEAR AFTER COMPLETION. CONTRACTOR SHALL BE RESPONSIBLE FOR ALL DAMAGE TO ANY PART OF THE PREMISES CAUSED BY EQUIPMENT FURNISHED AND INSTALLED UNDER THIS SECTION OF THE SPECIFICATIONS FOR A PERIOD OF ONE (1) YEAR AFTER DATE OF ACCEPTANCE OF HIS WORK. THE CONTRACTOR SHALL ADJUST ALL VALVES, CONTROLS, VACUUM BREAKERS AND INCIDENTAL ITEMS AND SHALL LEAVE THE SYSTEM IN PERFECT OPERATING CONDITION. THE CONTRACTOR SHALL FURNISH THE OWNER ALL MANUFACTURES' WRITTEN GUARANTEE OF MATERIALS AND EQUIPMENT, INCLUDING WATER HEATER WARRANTY REQUIREMENTS AND WATER STERILIZATION REPORT.

P9 - OPERATING MANUALS:

CONTRACTOR SHALL FURNISH THE OWNER WITH ALL OPERATING MANUALS AND MAINTENANCE INSTRUCTIONS FOR THE EQUIPMENT INSTALLED. MANUALS SHALL BE BOUNDED IN THREE RING LOOSE-LEAF BINDERS AND INDEXED BY PRODUCT TYPE. A SECTION WITHIN THE MANUAL SHALL INCLUDE THE NAME, TELEPHONE NUMBER AND ADDRESS OF ALL LOCAL SUPPLIERS OF ALL MATERIAL AND EQUIPMENT INSTALLED TOGETHER WITH NAME, TELEPHONE NUMBER AND ADDRESS OF ALL CONTRACTORS OF THE PROJECT. PROVIDE 3 SETS OF MANUALS TO THE OWNER. CONTRACTOR SHALL AFFIX A MAINTENANCE LABELS TO ALL EQUIPMENT REQUIRING ROUTINE MAINTENANCE.

P10 - COORDINATION AND VERIFICATION:

THE DRAWINGS ARE DIAGRAMMATIC AND INTENDED TO SHOW SCOPE. THE CONTRACTOR SHALL COORDINATE HIS WORK WITH OTHER TRADES TO PROVIDE THE BEST ARRANGEMENT OF ALL DUCTS, PIPES, CONDUIT, ETC... THE LOCATION OF EXISTING PIPING AND DUCTWORK SHOWN IS APPROXIMATE. CONTRACTOR SHALL VERIFY THEIR LOCATION PRIOR TO BEGINNING WORK OF THIS SECTION AND SHALL MAKE MODIFICATIONS AND ADJUSTMENTS REQUIRED TO INSTALL THE WORK OF

- A. THE EXACT LOCATION OF ALL PLUMBING EQUIPMENT SHALL BE VERIFIED WITH THE ARCHITECT AND STRUCTURAL ENGINEER PRIOR TO COMMENCEMENT OF WORK.
- B. COORDINATE WIRING, FUSED DISCONNECT SWITCHES AND CONDUIT REQUIREMENTS WITH THE ELECTRICAL CONTRACTOR. THESE ITEMS SHALL ALSO BE INSTALLED BY THE ELECTRICAL CONTRACTOR.

P11 - EXTERIOR OPENINGS:

COORDINATE LOCATIONS OF ALL EXTERIOR WALL AND ROOF OPENINGS WITH ALL RELEVANT TRADES AND PROVIDE WATERTIGHT FLASHINGS WHEREVER PENETRATIONS OCCUR. EXACT LOCATIONS AND SIZES MAY BE DEPENDENT UPON EQUIPMENT SELECTIONS. COORDINATE SIZES AND LOCATIONS OF ALL OPENINGS WITH APPROPRIATE EQUIPMENT REQUIREMENTS.

P12- UNDER FLOOR PIPING:

ALL UNDER FLOOR PIPING SHALL BE INSTALLED IN CONJUNCTION WITH THE GENERAL CONTRACTORS WORK SCHEDULE. NO UNDERGROUND WORK SHALL BE COVERED OR ENCLOSED UNTIL IT HAS BEEN INSPECTED AND TESTED. THE PLUMBING CONTRACTOR SHALL DO THE NECESSARY TRENCHING, SHORING AND BACKFILLING REQUIRED TO FULFILL HIS CONTRACT. BOTTOMS OF TRENCHES SHALL BE CUT TO GRADE. ALL OPENINGS AND STUB-UP FOR PLUMBING PIPING AND FIXTURES SHALL BE CAREFULLY LOCATED AND COORDINATED, OTHERWISE, PLUMBING CONTRACTOR SHALL CUT NEW OPENINGS AT HIS OWN EXPENSE, AND REIMBURSE OTHER SUBCONTRACTORS FOR ANY DAMAGE DONE TO THEIR WORK.

P13- UNDER FLOOR PIPING EXCAVATION AND BACKFILLING: ALL UNDER FLOOR PIPING SHALL BE INSTALLED IN CONJUNCTION WITH THE GENERAL CONTRACTORS WORK SCHEDULE. NO UNDERGROUND WORK SHALL BE COVERED OR ENCLOSED UNTIL IT HAS BEEN INSPECTED AND TESTED. THE PLUMBING CONTRACTOR SHALL DO THE NECESSARY TRENCHING, SHORING AND BACKFILLING REQUIRED TO FULFILL HIS CONTRACT. BOTTOMS OF TRENCHES SHALL BE CUT TO GRADE. ALL OPENINGS AND STUB-UP FOR PLUMBING PIPING AND FIXTURES SHALL BE CAREFULLY LOCATED AND COORDINATED, OTHERWISE, PLUMBING CONTRACTOR SHALL CUT NEW OPENINGS AT HIS OWN EXPENSE, AND REIMBURSE OTHER SUBCONTRACTORS FOR ANY DAMAGE DONE TO THEIR WORK.

<u>P14 – DOMESTIC COLD WATER AND HOT WATER PIPING:</u> ABOVE GRADE TYPE "L" COPPER, ASTM B-88 COLOR CODED AND BELOW GRADE TYPE "K" COPPER, ASTM B-88, COLD HARD DRAWN SEAMLESS COPPER TUBING. WATER PIPING SHALL BE ABOVE GROUND AS MUCH AS POSSIBLE EXCEPT TO ISLANDS. ALL PIPE CONNECTIONS SHALL RISE ABOVE FLOOR IN INTERIOR WALLS. NO CONNECTIONS UNDER FLOOR. WATER SUPPLY PIPE FITTINGS SHALL BE WROUGHT COPPER, ANSI B16.22 AND CAST FITTINGS WITH NON-LEAD SOLDER JOINTS (100% LEAD FREE). PIPING 4 IN. AND LARGER SHALL BE BELL AND SPIGOT CLASS 50 DUCTILE IRON PIPE

P15 - SANITARY SOIL WASTE AND VENT PIPING:

CENTRIFUGALLY CAST, CEMENT-LINED INSIDE.

ABOVE AND BELOW SLAB WASTE AND VENT SHALL BE SCHEDULE 40 PVC SOIL PIPE AND FITTINGS ASSEMBLED WITH SOLVENT CEMENT JOINTS. DEBURR PIPE AFTER CUTTING. CLEAN PIPE AND FITTINGS WITH PURPLE PRIMER. PIPING 3" DIAMETER AND SMALLER SHALL BE SLOPED AT A MINIMUM OF 1/4" (2%) PER FOOT. PIPING 4" IN DIAMETER AND LARGER MAY BE SLOPED AT A MINIMUM OF 1/8" PER FOOT. CONTRACTOR SHALL BID THE USE OF CAST IRON PIPING WHEN PVC IS NOT ALLOWED BY THE LOCAL AUTHORITY.

P16 - CLEANOUTS:

PROVIDE CLEANOUTS WHERE INDICATED AND REQUIRED. UNLESS OTHERWISE INDICATED, CLEANOUTS SHALL BE ACCESSIBLE WITH EXTENSIONS TO GRADE, TO OUTSIDE OF BUILDINGS, OR TO FLOORS ABOVE AS INDICATED OR REQUIRED. DO NOT LOCATE CLEANOUTS IN PUBLIC LOBBIES AND PUBLIC CORRIDORS UNLESS APPROVED BY ARCHITECT. FURNISH AND INSTALL CLEANOUTS AT CHANGES IN DIRECTION, AND AS REQUIRED BY LOCAL ORDINANCE AND CODES.

P17 - INDIRECT AND CONDENSATE DRAINS:

HARD DRAWN, TYPE "M" OR "L" COPPER TUBE, ASTM B88 AND WROUGHT COPPER FITTINGS, ANSI B16.22, SOLDER JOINT TYPE, OR PVC. COORDINATE CONDENSATE TRAP INSTALLATION WITH AIR CONDITIONING UNIT MANUFACTURER. ALL INTERIOR CONDENSATE DRAIN PIPING SHALL BE INSULATED. DRAIN SHALL BE SLOPED AT A MINIMUM OF 1%. DRAIN SHALL TERMINATE AT THE CLOSEST CODE APPROVED DISPOSAL SITE.

EVERY PLUMBING FIXTURE SHALL BE INDEPENDENTLY VALVED. VALVES SHALL BE MANUFACTURED BY NIBCO, HAMMOND, POWELL, STOCKHAM, WATTS OR EQUIVALENT APPROVED BY THE ENGINEER. GATE VALVES SHALL CONFORM TO MSS-SP-80 FOR BRONZE AND MSS-SP-70 FOR IRON, VALVES 2" AND SMALLER SHALL BE NIBCO T-113 OR S-113 OR APPROVED EQUIVALENT. BALL VALVES SHALL HAVE CAST BRONZE BODY, BLOWOUT PROOF STEMS, FULL SIZE PORT, 316 STAINLESS STEEL TRIM, TEFLON SEAT AND SEAL AND THRUST WASHERS. VALVES 2" AND SMALLER SHALL BE NIBCO T-585-70-66 OR APPROVED EQUIVALENT.

<u>P19 – NATURAL GAS PIPING:</u>

PIPE SHALL BE NEW SCHEDULE 40 BLACK STEEL CONFORMING TO ASTM STANDARDS, WITH 150 LB. MIN. BLACK MALLEABLE IRON SCREWED FITTINGS AND COUPLINGS. GAS PIPING INSTALLED UNDERGROUND SHALL BE PROTECTED FROM CORROSION (MACHINE WRAPPED). GATE VALVES ONE INCH AND SMALLER SHALL BE LEVER HANDLE TYPE WITH CHECK, ALL BRONZE, SCREWED. 1-1/4" AND LARGER VALVES SHALL BE IRON BODY WITH BRONZE SQUARE HEAR PLUG. PROVIDE OPERATING WRENCH WHERE REQUIRED FOR EACH VALVE. OUTSIDE UNDERGROUND PIPING MAY BE PLASTIC PIPE WHERE ALLOWED BY THE LOCAL AUTHORITY HAVING JURISDICTION. PLASTIC PIPING SHALL CONFORM TO "ASTM D 2513". PLASTIC PIPING SHALL BE INSTALLED BY A CERTIFIED INSTALLER. TRANSITION FROM BELOW GROUND SHALL BE PROVIDED BY THE INSTALLATION OF AN ANODELESS RISER. PLASTIC PIPING SHALL BE INSTALLED

WITH A #10 TRACER WIRE.

FACTORY FABRICATED WITH STAINLESS STEEL CONSTRUCTION SIMILAR TO JOSAM NO. 75007 (IF REQUIRED BY LOCAL CODES). AIR CHAMBERS WILL NOT BE PERMITTED AS A SUBSTITUTE FOR SHOCK ABSORBERS.

<u>P21 – PIPE HANGERS AND SUPPORTS:</u>

HOLD HORIZONTAL PIPE RUNS FIRMLY IN PLACE USING APPROVED STEEL AND IRON HANGERS, SUPPORTS. AND/OR PIPE RESTS UNLESS OTHERWISE INDICATED. SUSPEND HANGER RODS FROM CONCRETE INSERTS OR FROM APPROVED BRACKETS, CLAMPS OR CLIPS. HANG PIPES INDIVIDUALLY OR IN GROUPS IF SUPPORTING STRUCTURE IS ADEQUATE TO SUPPORT WEIGHT OF PIPING AND FLUID. EXCEPT FOR BURIED PIPING, HANG OR SUPPORT PIPE RUNS SO THAT THEY MAY EXPAND OR CONTRACT FREELY WITHOUT STRAIN TO PIPE OR EQUIPMENT. HANGERS SHALL BE SUPPLIED WITH FACTORY INSTALLED ISOLATION AND DI-CHROMATE FINISH.

P22 – INSULATION:

ALL HOT AND COLD DOMESTIC WATER LINES, LAVATORY DRAINS, SINK AND CONDENSATE DRAINS TO BE INSULATED WITH 1/2" FIBERGLASS MOLDED PIPE COVERING ABOVE AND BELOW GRADE. HOT WATER PIPING SHALL BE INSULATED AS REQUIRED BY THE ENERGY CODE AND THE AUTHORITY HAVING JURISDICTION.

<u>P23 – TRAP PRIMERS:</u>

WHERE SHOWN ON THE DRAWINGS OR REQUIRED BY THE LOCAL PLUMBING CODE, INSTALL AUTOMATIC TRAP PRIMERS ON COLD WATER SUPPLY AT NEAREST FIXTURE AND RUN DRAIN TO TRAP SEAL BEING PROTECTED. PROVIDE ARCHITECT APPROVED ACCESS PANELS WHEN PRIMERS ARE INSTALLED IN WALLS.

<u>P24 – ROOF FLASHING:</u>

SANITARY VENT FLASHINGS: SEMCO 1100-3 OR 1100-5, WITH ONE-PIECE LEAD FLASHING AND COUNTER FLASHING SLEEVE. OTHER PIPE THROUGH ROOF FLASHING: SEMCO 1100-2 OR 1100-4, ONE-PIECE 4 LB. LEAD FLASHING AND COUNTER FLASHING SLEEVE.

P25 - WATER STERILIZATION:

BEFORE ANY USE OF THE SYSTEM IS MADE FOR DOMESTIC PURPOSES, IT SHALL BE STERILIZED WITH APPROVED AGENTS. THE LINE IS THEN FLUSHED OUT UNTIL ALL TRACES OF CHEMICAL HAVE BFFN RFMOVFD.

P26 - TESTING AND INSPECTION:

THE ENTIRE PLUMBING SYSTEM INCLUDING ALL SEWER, GAS, WATER. WASTE AND VENT PIPING SHALL BE TESTED BEFORE COVERING, ENCLOSING OR INSULATING TO THE SATISFACTION OF THE ARCHITECT AND LOCAL BUILDING INSPECTOR. THE WATER USED FOR THESE TESTS SHALL BE OBTAINED FROM A PORTABLE SOURCE OF SUPPLY IF REQUIRED. WORK SHALL BE INSPECTED FOR COMPLIANCE WITH CODES, ORDINANCES, REGULATIONS AND ADHERENCE TO CONTRACT DOCUMENTS. PLUMBING CONTRACTOR SHALL SUPPLY OWNER WITH SIGNED FORMS OR PROOF OF ACCEPTANCE BY THE LOCAL AUTHORITY BEFORE CONTINUING FROM ONE STAGE TO ANOTHER. FINAL APPROVAL SHALL BE OBTAINED BEFORE FINAL PAYMENT IS MADE ON THE CONTRACT.

UPON COMPLETION OF THE WORK UNDER THIS SECTION. THE CONTRACTOR SHALL REMOVE ALL SURPLUS MATERIALS, EQUIPMENT AND DEBRIS INCIDENTAL TO THIS WORK AND LEAVE THE PREMISES CLEAN AND ORDERLY.

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**PLUMBING SPECIFICATIONS** AND DETAILS